

### Addendum No. 1 Page 1 of 1

DATE: April 14, 2016

Joliet Junior College 1215 Houbolt Road Joliet, IL 60431

**TO:** Prospective Bidders **SUBJECT:** Addendum No. 1

**PROJECT NAME:** City Center Campus Audio Visual Equipment

JJC PROJECT NO.: B16016

This Addendum forms a part of the Bidding and Contract Documents and modifies the original bidding document as posted on the JJC website. Acknowledge receipt of this addendum in the space provided on the Bid Form. FAILURE TO DO SO MAY SUBJECT BIDDER TO DISQUALIFICATION.

### **Clarifications/Modifications to bid documents:**

- 1. A second scope review meeting will be held on April 26, 2016 at 9:00a.m. in room L1005 (same as pre-bid meeting). This meeting is not mandatory. However, bidders are encourage to attend for further scope clarification. The AV consultant will be in attendance to answer questions.
- 2. Addendum questions may be submitted anytime. However, final questions will be due by the end of the business day on April 29, 2016. A final addendum will be issued by the end of the day May 4, 2016.
- 3. The bid due date will be extended to May 10, 2016 at 9:00a.m. Location/room number remain the same.
- 4. The following drawings are included in this addendum:

TA707 AUDIOVISUAL SIGNAL FLOW DIAGRAMS

TA800 AUDIOVISUAL DETAILS


TA801 AUDIOVISUAL DETAILS


TA802 AUDIOVISUAL DETAILS

TA803 AUDIOVISUAL DETAILS

TA804 AUDIOVISUAL DETAILS TA805 AUDIOVISUAL DETAILS

TA806 AUDIOVISUAL DETAILS

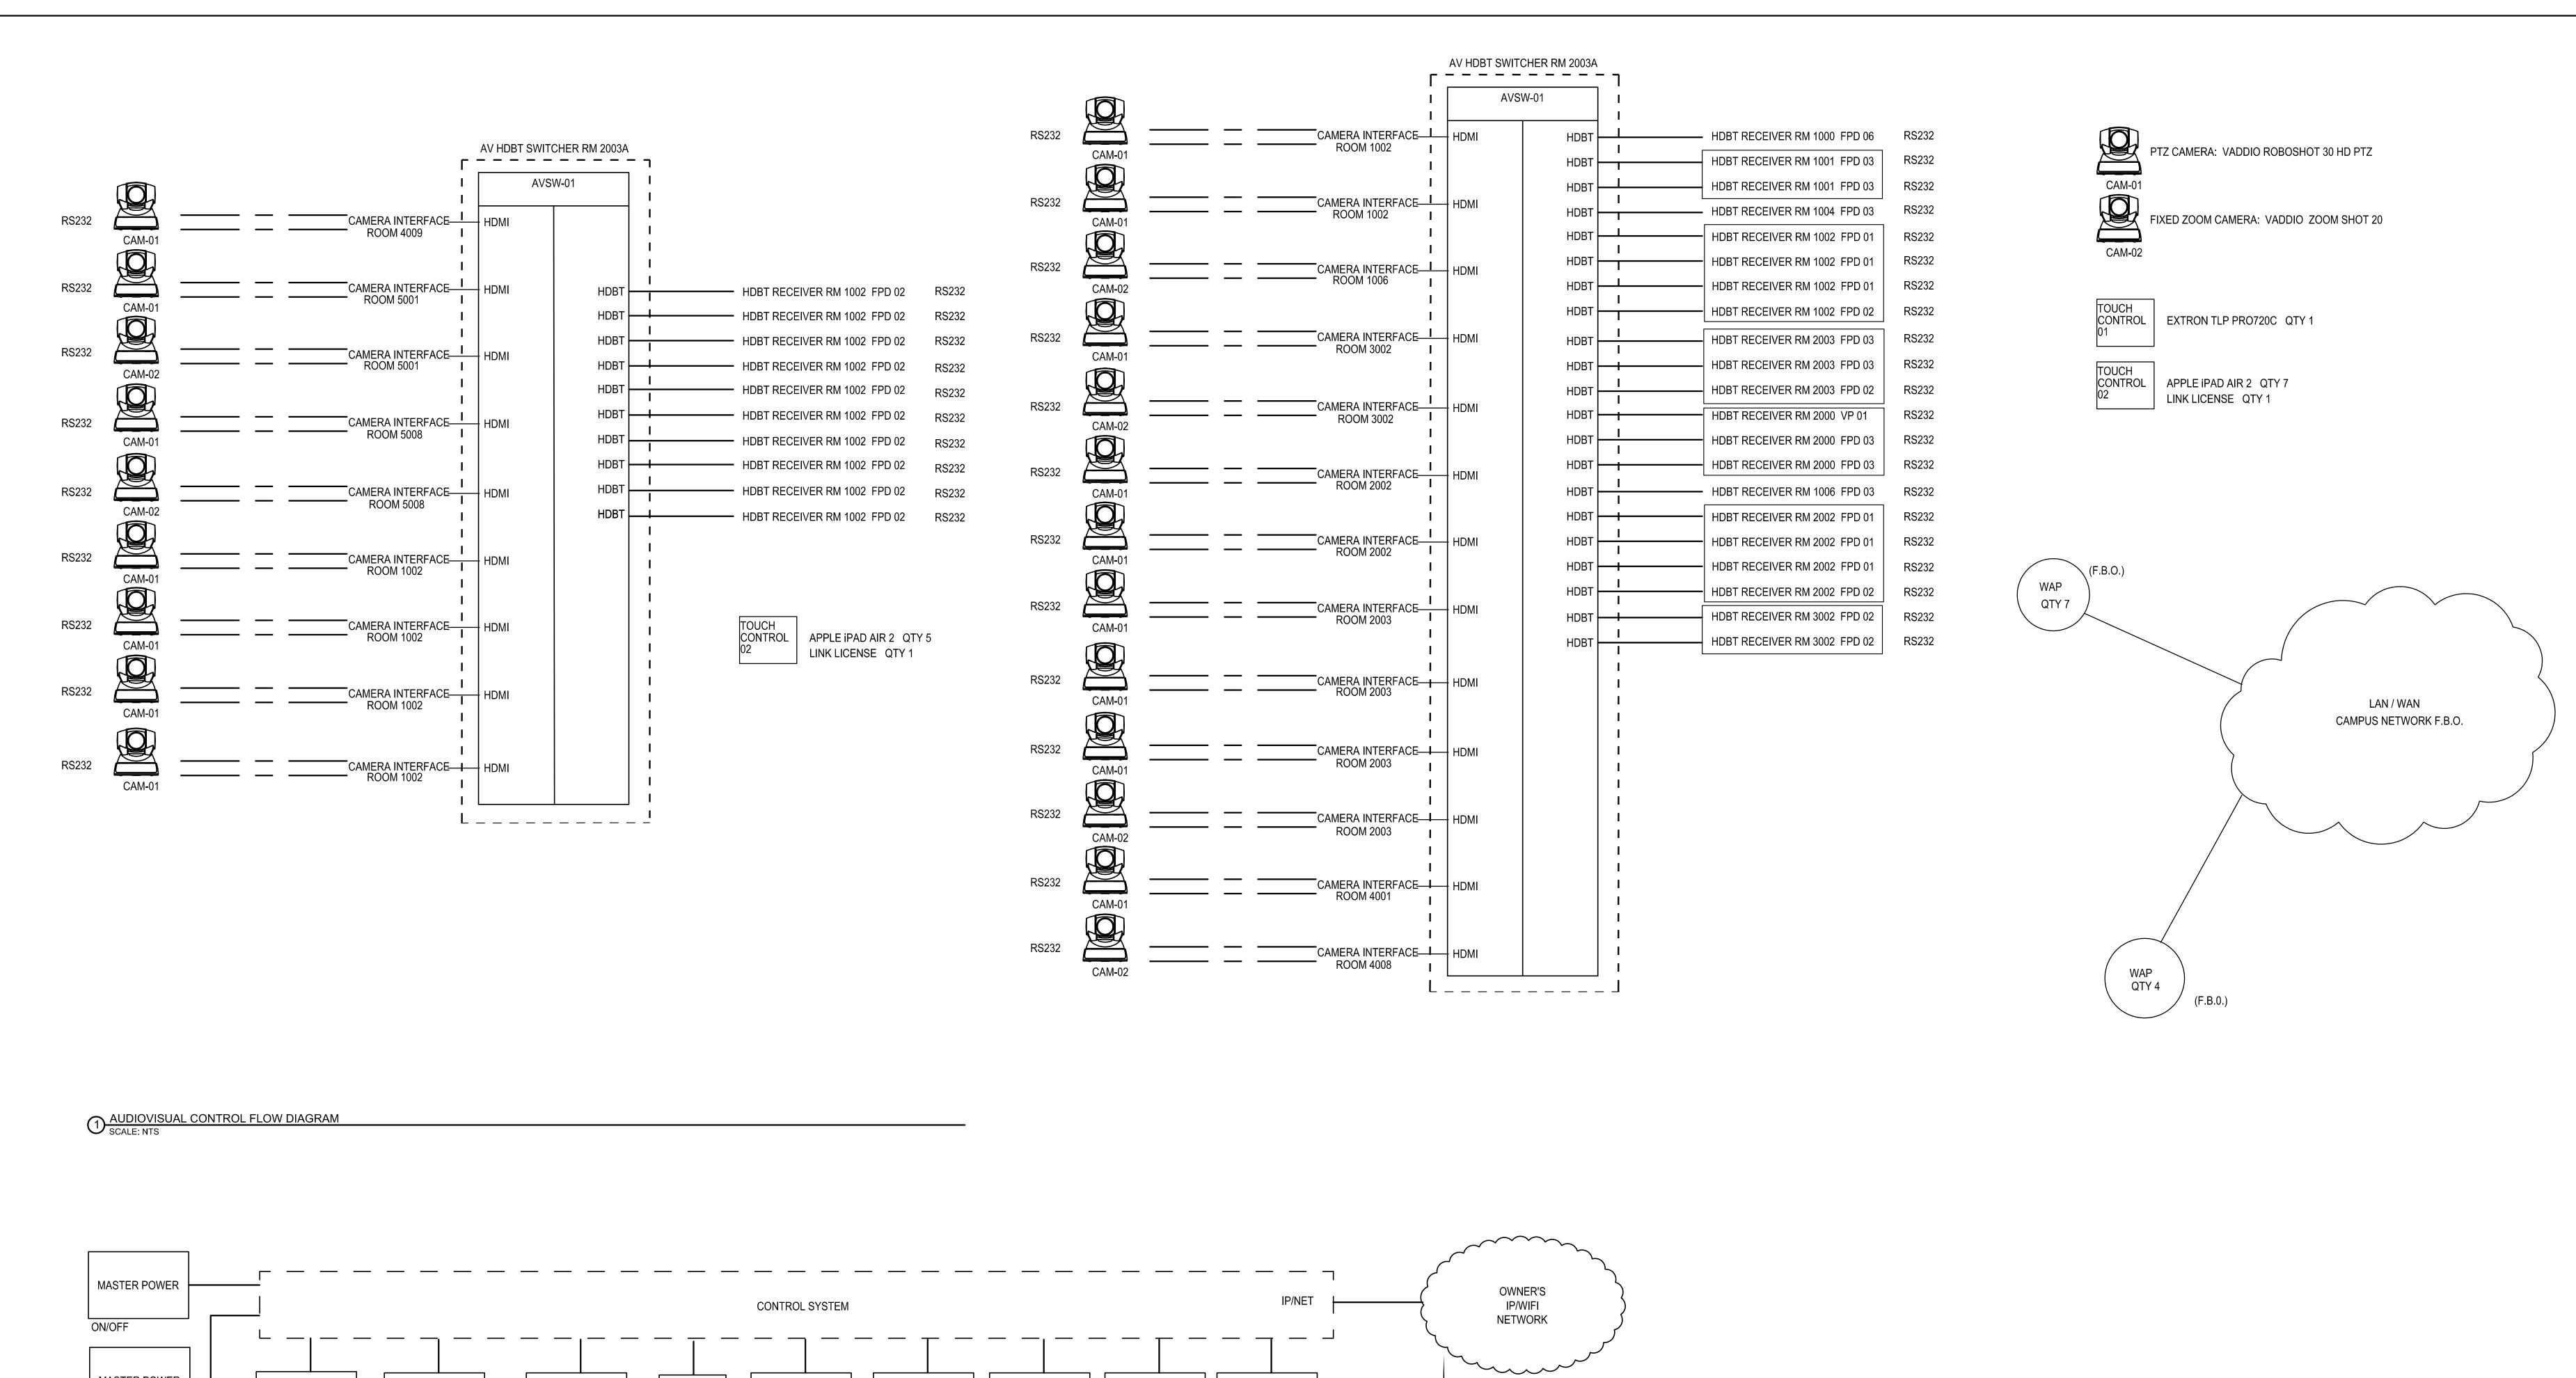

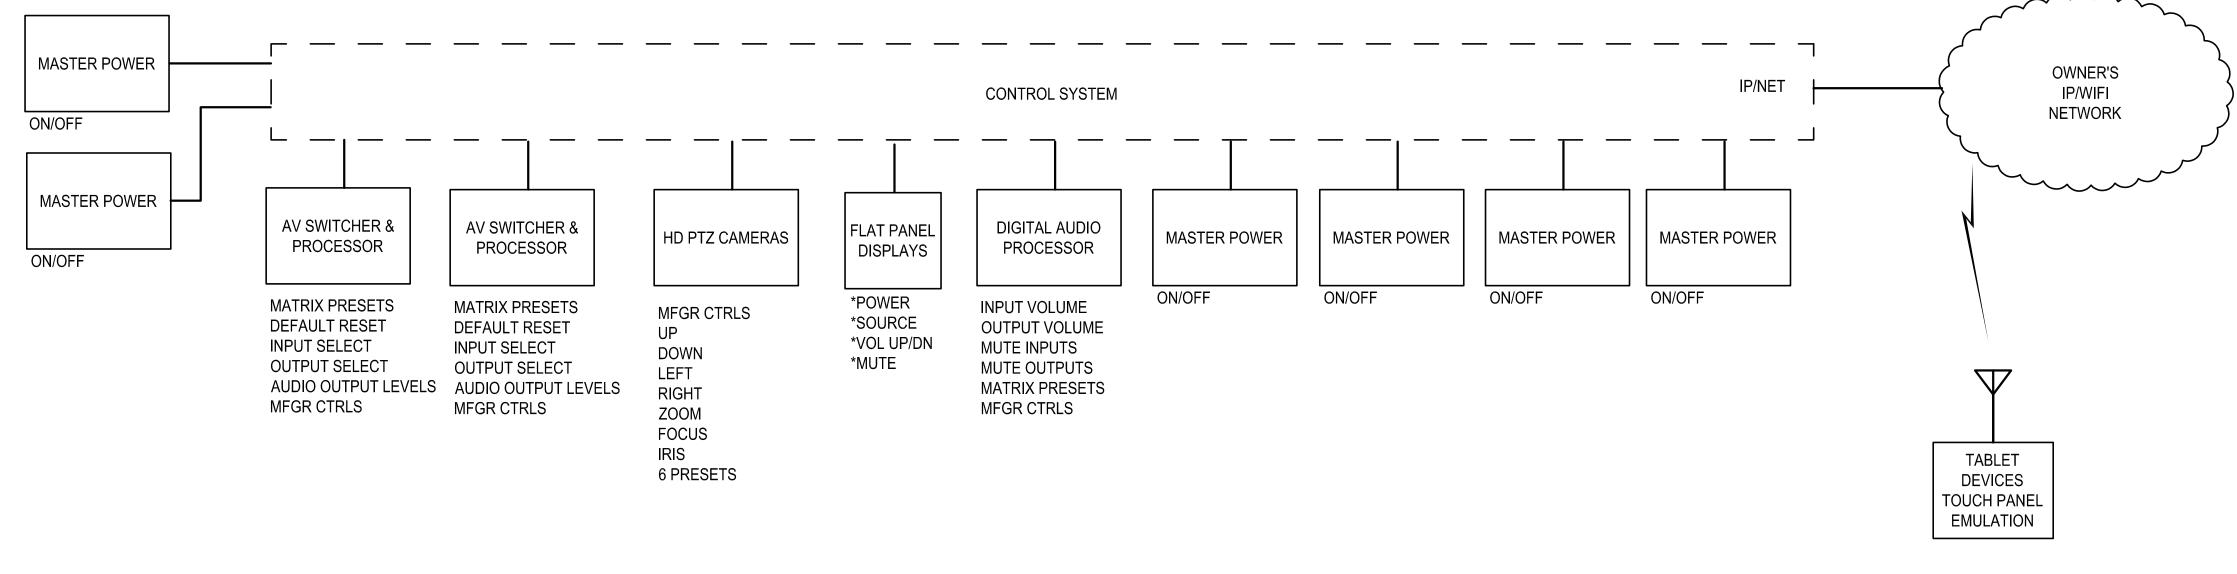

T: 312.559.4585

AUDIOVISUAL CONTROL DIAGRAM
NTS

**RST** 

CHICAGO, IL 60661


P: 312.496.0000

NAPERVILLE, IL 60563

T: 312.559.4585

T: 248.644.0990


100% CD FOR CONSTRUCTION NOTE: CONTRACTOR SHALL VERIFY ALL DIMENSIONS AND CONDITIONS AT JOB SITE AND BE FULLY RESPONSIBLE FOR SAME. PROJECT NO. **REVISIONS AUDIOVISUAL SIGNAL FLOW DIAGRAMS** W W ENGINEERING E.F. WHITNEY, INC. **RST** CDB 810-048-023 KEMPER ARCHITECTS DATE **REVISION A** 09.16.14 TRACED REVISION B 09.18.14 **CITY CENTER CAMPUS RST** SHEET NO. 10.29.14 REVISION C 125 N. HALSTED STREET, 2 N. RIVERSIDE PLAZA 1100 WARRENVILLE **568 ANN STREET** 04 AV 100% DD FINAL REVISION 11.24.15 **JOLIET JUNIOR COLLEGE** TA707 05 100% CD FOR CONSTRUCTION 03.25.16 CHECKED **SUITE 301 ROAD**, #400W CHICAGO, IL 60606 BIRMINGHAM, MI 48009

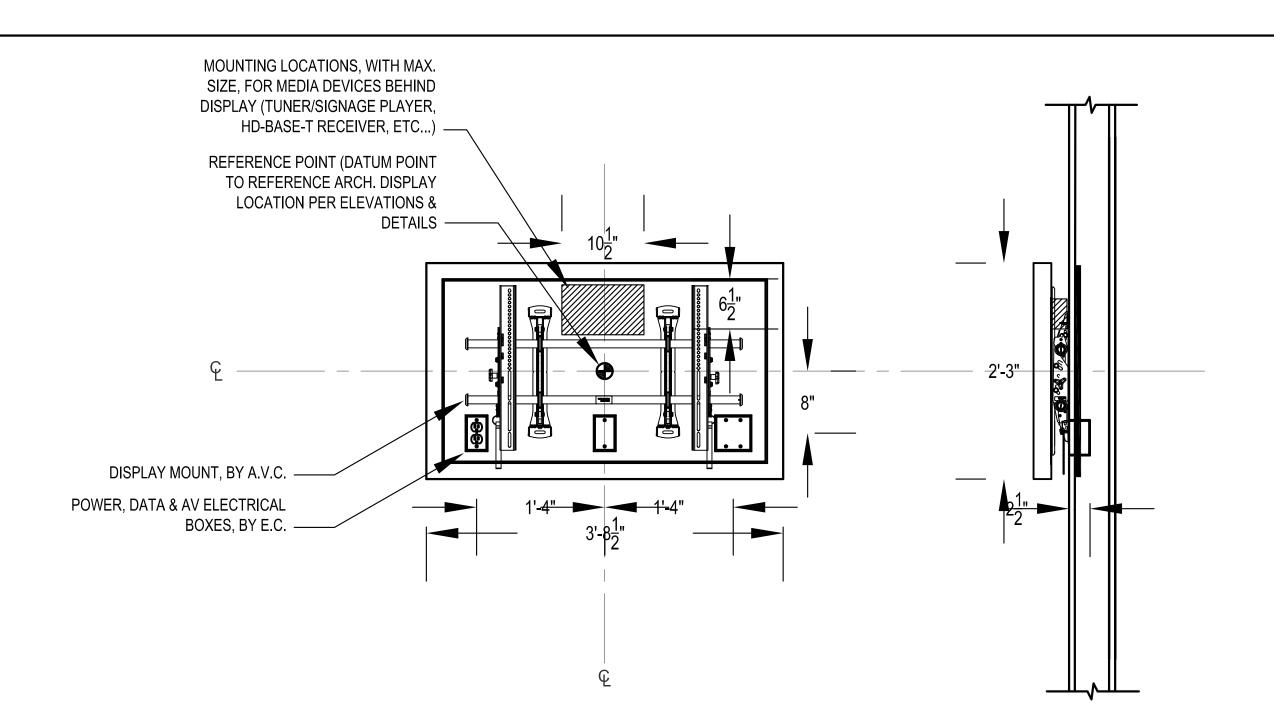

THE DIMENSIONING, AS SHOWN, REPRESENTS THE BLOCKING AND BACK BOX POSITIONING REQUIREMENTS FOR A GENERAL CROSS-SECTION OF MANUFACTURERS AND PRODUCTS FOR THIS SIZE FLAT PANEL DISPLAY. DIMENSIONS, AS SHOWN, WILL ACCOMMODATE MOST DISPLAYS CURRENT TO THE MARKET PLACE, BUT MAY NOT REFLECT ALL FUTURE DISPLAYS OR MANUFACTURERS.

- 2. GENERAL CONTRACTOR TO PROVIDE NECESSARY BLOCKING TO SUPPORT FLAT PANEL DISPLAY. WEIGHT: APPROX. 75LBS. BACKING DIMENSIONS GIVEN TO SPAN MULTIPLE STUDS IN WALL.
- 3. AV CONTRACTOR TO VERIFY IF DISPLAY IS TO BE VERTICALLY CENTERED TO SCREEN OR CHASSIS.
- 4. ALL BOXES, CONDUIT AND POWER BY EC. DATA CONNECTORS, PLATE AND CABLE BY LOW VOLTAGE CABLE PROVIDER OR AS WITHIN WRITTEN SPECIFICATIONS.
- 5. COORDINATE REFERENCE POINT LOCATIONS WITH ARCHITECTURAL DRAWINGS.

5 AUDIOVISUAL DETAIL - 40" FLAT PANEL DISPLAY - SURFACE MOUNTED NTS

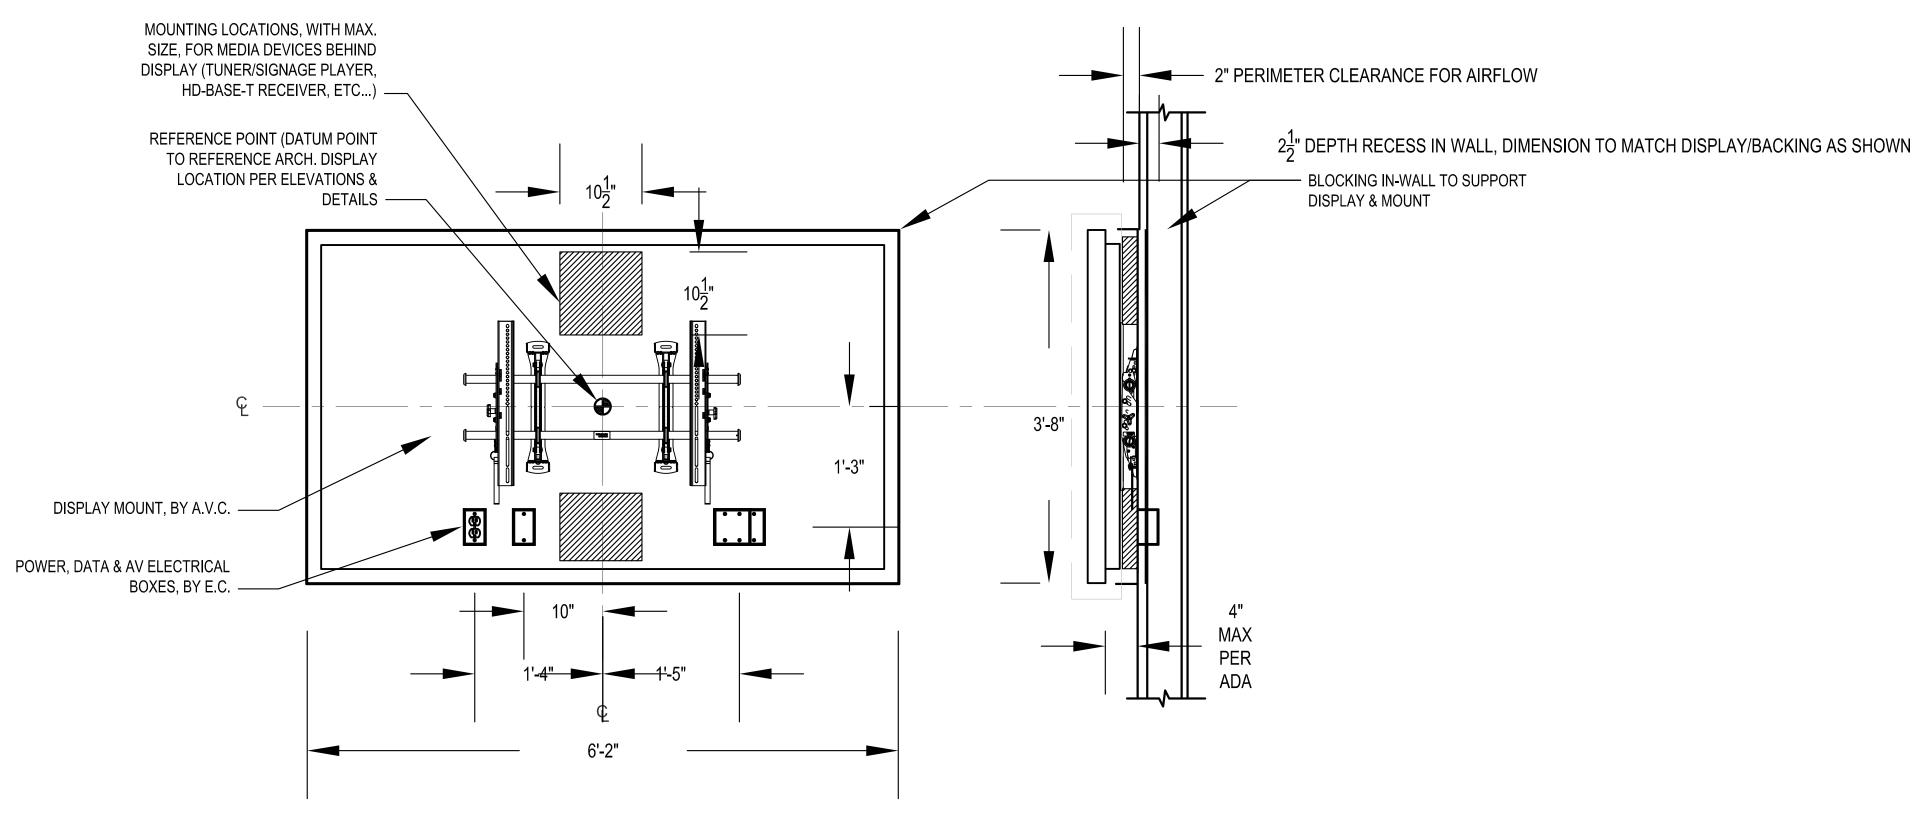

- THE DIMENSIONING, AS SHOWN, REPRESENTS THE BLOCKING AND BACK BOX POSITIONING REQUIREMENTS FOR A GENERAL CROSS-SECTION OF MANUFACTURERS AND PRODUCTS FOR THIS SIZE FLAT PANEL DISPLAY. DIMENSIONS, AS SHOWN, WILL ACCOMMODATE MOST DISPLAYS CURRENT TO THE MARKET PLACE, BUT MAY NOT REFLECT ALL FUTURE DISPLAYS OR MANUFACTURERS.
- 2. GENERAL CONTRACTOR TO PROVIDE NECESSARY BLOCKING TO SUPPORT FLAT PANEL DISPLAY. WEIGHT: APPROX. 250LBS. BACKING DIMENSIONS GIVEN TO SPAN MULTIPLE STUDS IN WALL.
- 3. AV CONTRACTOR TO VERIFY IF DISPLAY IS TO BE VERTICALLY CENTERED TO SCREEN OR CHASSIS.
- 4. ALL BOXES, CONDUIT AND POWER BY EC. DATA CONNECTORS, PLATE AND CABLE BY LOW VOLTAGE CABLE PROVIDER OR AS WITHIN WRITTEN SPECIFICATIONS.
- 5. COORDINATE REFERENCE POINT LOCATIONS WITH ARCHITECTURAL DRAWINGS.


4 AUDIOVISUAL DETAIL - 80" FLAT PANEL DISPLAY - SURFACE MOUNTED NTS

NOTE: CONTRACTOR SHALL VERIFY ALL DIMENSIONS AND CONDITIONS AT JOB SITE AND BE FULLY RESPONSIBLE FOR SAME.

REVISIONS			DRAWN	PREPARED
NO:	DESCRIPTION:	DATE:	TL	RST OFF.
01	REVISION A	09.16.14	TRACED	APPROVED
02	REVISION B	09.18.14		
03	REVISION C	10.29.14	TL	RST
04	AV 100% DD FINAL REVISION	11.24.15		
05	100% CD FOR CONSTRUCTION	03.25.16	CHECKED	APPROVED
			TL	RST
			• <del>-</del>	





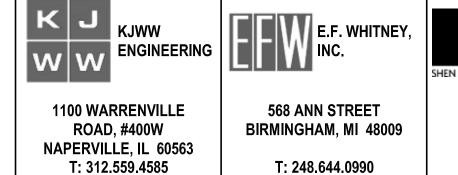









**TOP VIEW ELECTRICAL** HANGING POINTS -HANGING POINTS 5 1/2 in [139 mm] 240 in [6096 mm] **IMAGE (1.85:1)** VIEWING [33 mm] 147 1/4 in 273 in [6933 mm] [374 mm] [3302 mm] 9 1/4 in —268 in [6807 mm] BATTEN ——— **AUDIENCE LEFT** [235 mm] FRONT VIEW/VIEWING SIDE **SIDE VIEW** 

PROJECTION SCREEN DETAIL
SCALE: NTS

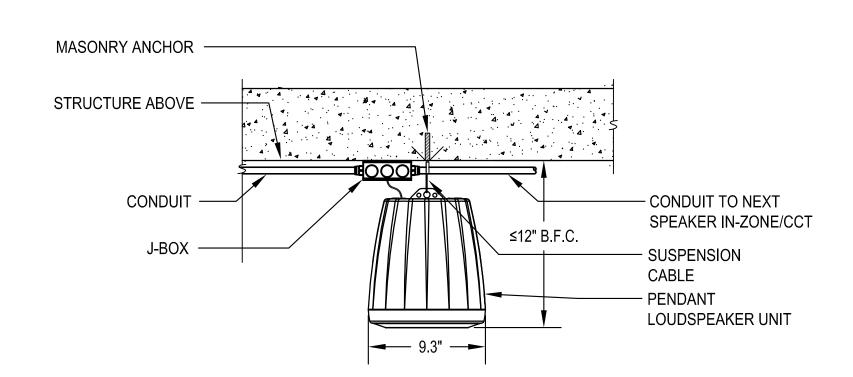


2 AUDIOVISUAL DETAIL - PENDANT SPEAKER SCALE: NTS

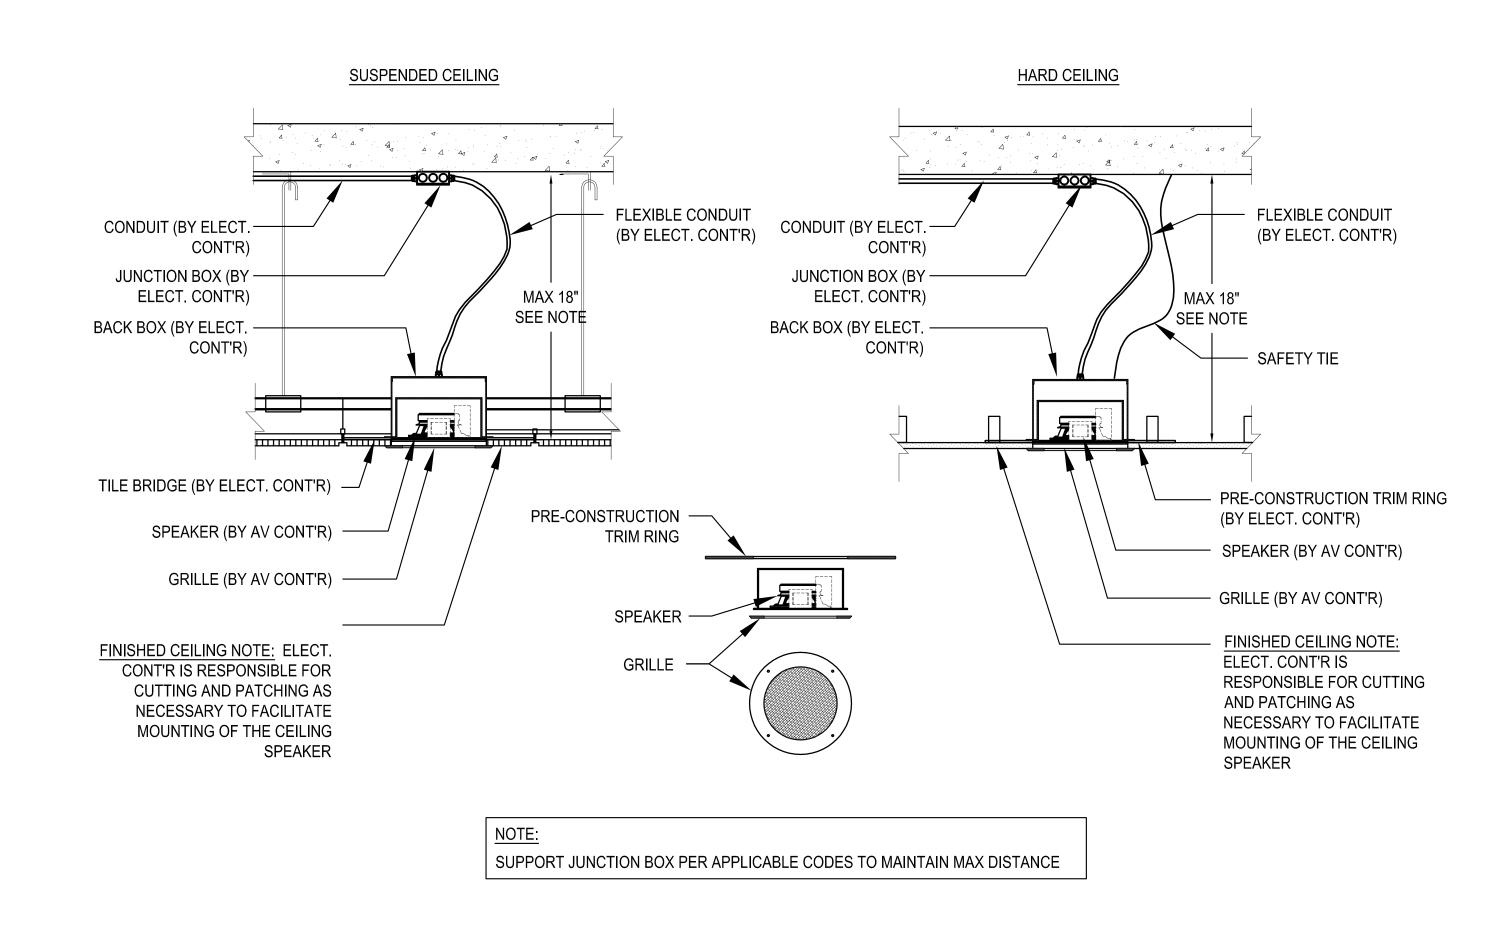


AUDIOVISUAL DETAIL - CEILING SPEAKER
SCALE: NTS

100% CD FOR CONSTRUCTION	
AUDIOVISUAL DETAILS	PROJECT NO.
	DATE APRIL 11, 2016
CITY CENTER CAMPUS	SHEET NO.
JOLIET JUNIOR COLLEGE	TA800

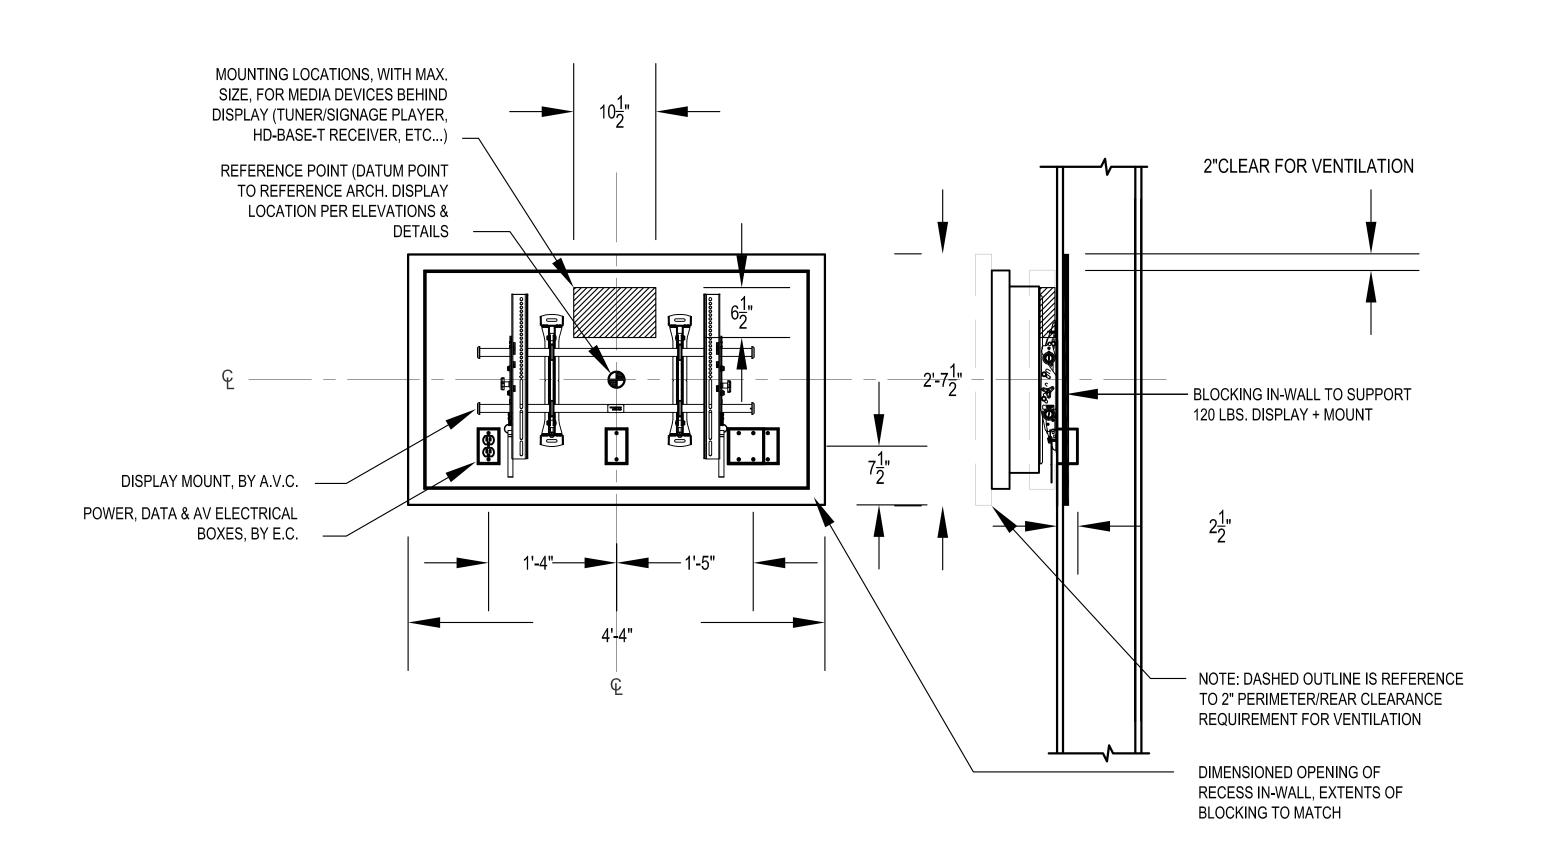

# 4 AUDIOVISUAL DETAIL - 55" FLAT PANEL DISPLAY - FULLY-RECESSED MOUNTED SCALE: NTS

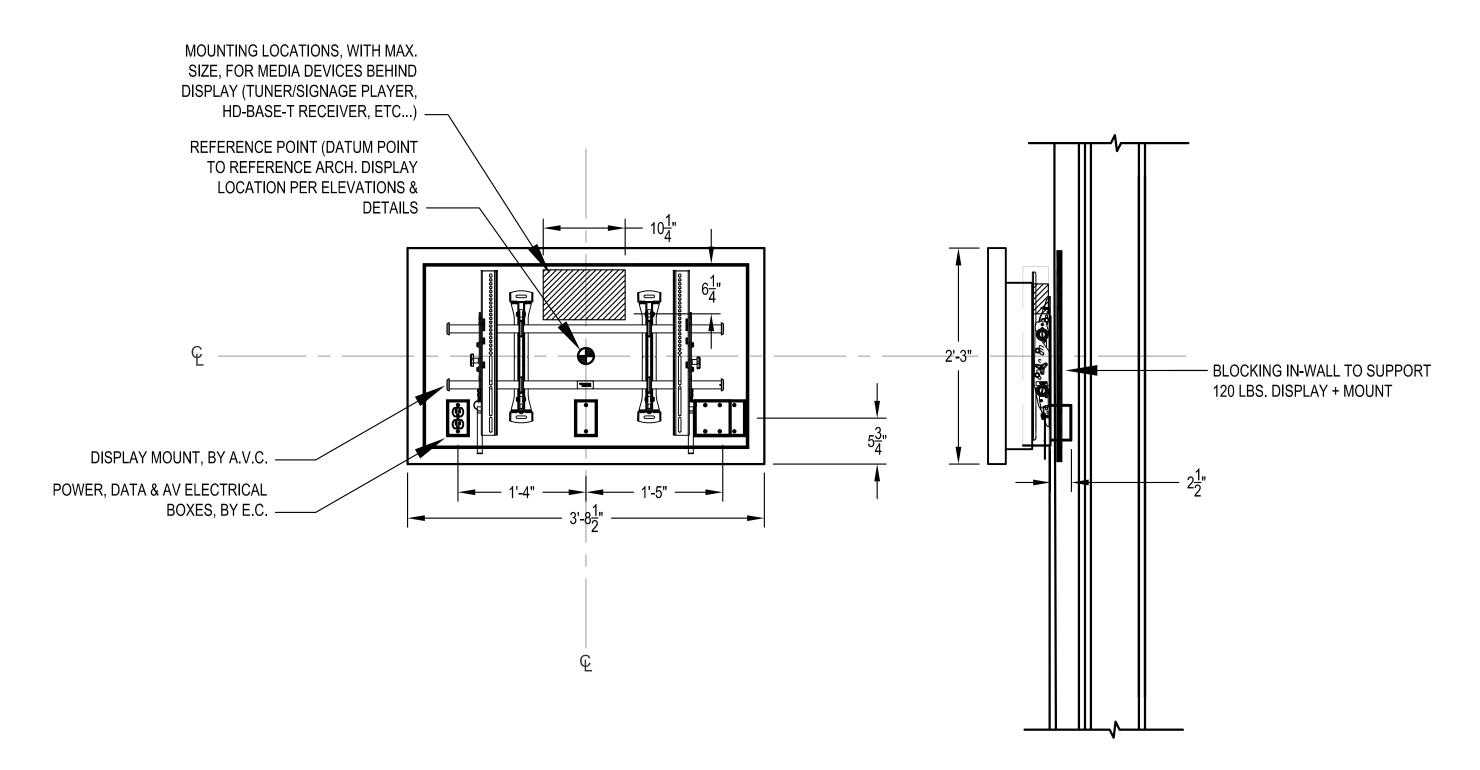


WIDTH 28-27/64" HEIGHT 18-1/2" DEPTH 2-31/64"

- THE DIMENSIONING, AS SHOWN, REPRESENTS THE BLOCKING AND BACK BOX POSITIONING REQUIREMENTS FOR A GENERAL CROSS-SECTION OF MANUFACTURERS AND PRODUCTS FOR THIS SIZE FLAT PANEL DISPLAY. DIMENSIONS, AS SHOWN, WILL ACCOMMODATE MOST DISPLAYS CURRENT TO THE MARKET PLACE, BUT MAY NOT REFLECT ALL FUTURE DISPLAYS OR MANUFACTURERS.
- 2. GENERAL CONTRACTOR TO PROVIDE NECESSARY BLOCKING TO SUPPORT FLAT PANEL DISPLAY. WEIGHT: APPROX. 75LBS. BACKING DIMENSIONS GIVEN TO SPAN MULTIPLE STUDS IN WALL.
- 3. AV CONTRACTOR TO VERIFY IF DISPLAY IS TO BE VERTICALLY CENTERED TO SCREEN OR CHASSIS.
- 4. ALL BOXES, CONDUIT AND POWER BY EC. DATA CONNECTORS, PLATE AND CABLE BY LOW VOLTAGE CABLE PROVIDER OR AS WITHIN WRITTEN SPECIFICATIONS.
- 5. COORDINATE REFERENCE POINT LOCATIONS WITH ARCHITECTURAL DRAWINGS.

3 AUDIOVISUAL FLAT PANEL DETAIL - 46" SURFACE MOUNTED NTS


NOTE: CONTRACTOR SHALL VERIFY ALL DIMENSIONS AND CONDITIONS AT JOB SITE AND BE FULLY RESPONSIBLE FOR SAME.

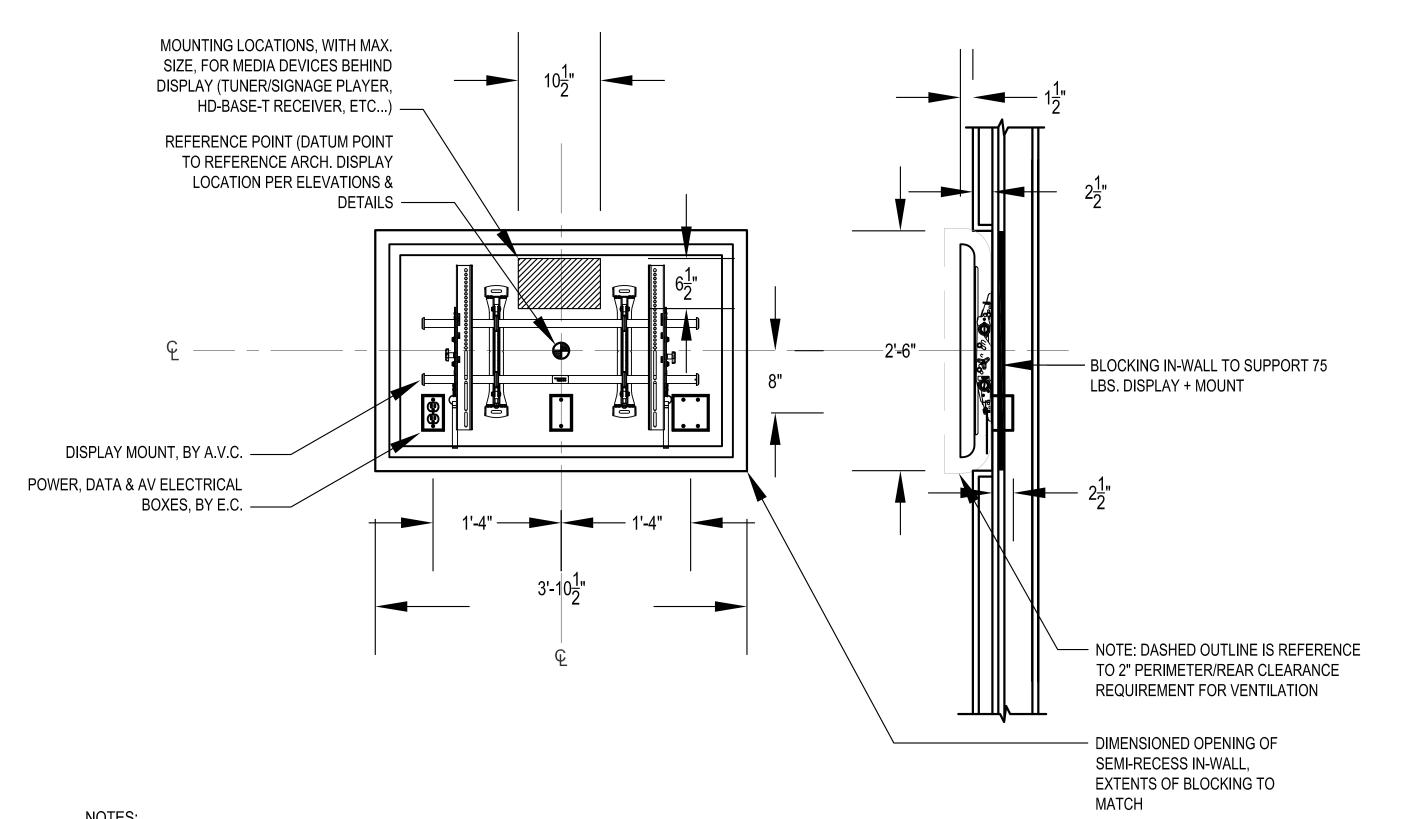

THE DIMENSIONING, AS SHOWN, REPRESENTS THE BLOCKING AND BACK BOX POSITIONING REQUIREMENTS FOR A GENERAL CROSS-SECTION OF MANUFACTURERS AND PRODUCTS FOR THIS SIZE FLAT PANEL DISPLAY. DIMENSIONS, AS SHOWN, WILL ACCOMMODATE MOST DISPLAYS CURRENT TO THE MARKET PLACE, BUT MAY NOT REFLECT ALL FUTURE DISPLAYS OR MANUFACTURERS.

- 2. GENERAL CONTRACTOR TO PROVIDE NECESSARY BLOCKING TO SUPPORT FLAT PANEL DISPLAY. WEIGHT: APPROX. 75LBS. BACKING DIMENSIONS GIVEN TO SPAN MULTIPLE STUDS IN WALL.
- 3. AV CONTRACTOR TO VERIFY IF DISPLAY IS TO BE VERTICALLY CENTERED TO SCREEN OR CHASSIS.
- 4. ALL BOXES, CONDUIT AND POWER BY EC. DATA CONNECTORS, PLATE AND CABLE BY LOW VOLTAGE CABLE PROVIDER OR AS WITHIN WRITTEN SPECIFICATIONS.
- 5. COORDINATE REFERENCE POINT LOCATIONS WITH ARCHITECTURAL DRAWINGS.


### 2 AUDIOVISUAL DETAIL - 47" FLAT PANEL DISPLAY - SEMI-RECESSED MOUNTED SCALE: NTS

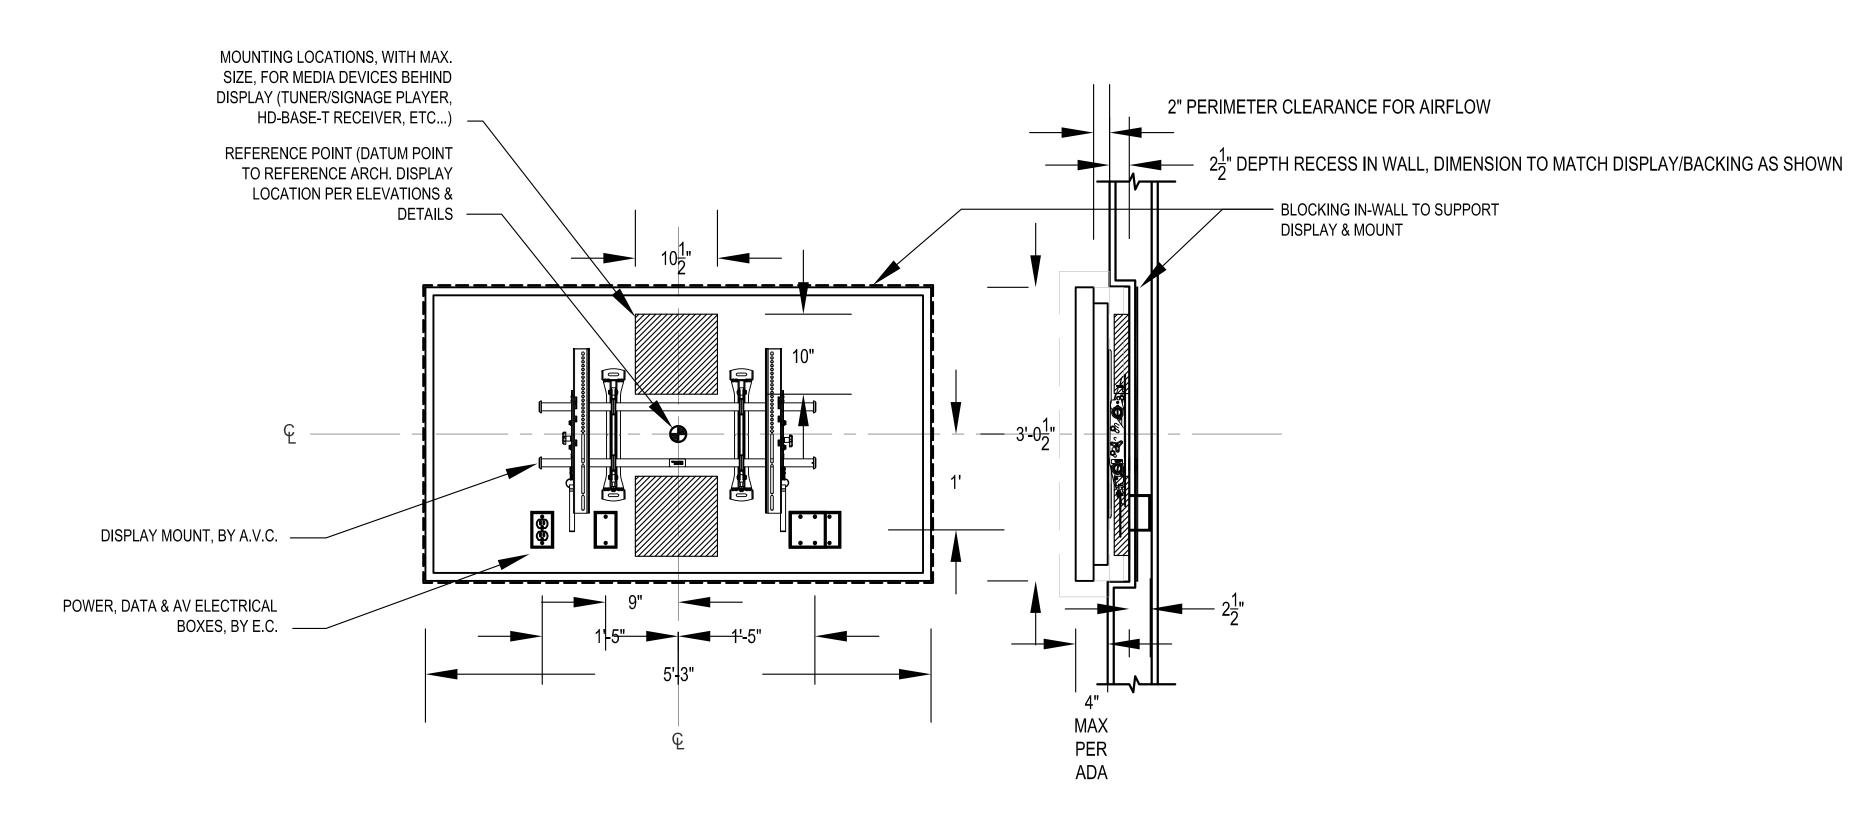



- THE DIMENSIONING, AS SHOWN, REPRESENTS THE BLOCKING AND BACK BOX POSITIONING REQUIREMENTS FOR A GENERAL CROSS-SECTION OF MANUFACTURERS AND PRODUCTS FOR THIS SIZE FLAT PANEL DISPLAY. DIMENSIONS, AS SHOWN, WILL ACCOMMODATE MOST DISPLAYS CURRENT TO THE MARKET PLACE, BUT MAY NOT REFLECT ALL FUTURE DISPLAYS OR MANUFACTURERS.
- 2. GENERAL CONTRACTOR TO PROVIDE NECESSARY BLOCKING TO SUPPORT FLAT PANEL DISPLAY. WEIGHT: APPROX. 130LBS. BACKING DIMENSIONS GIVEN TO SPAN MULTIPLE STUDS IN WALL.
- 3. AV CONTRACTOR TO VERIFY IF DISPLAY IS TO BE VERTICALLY CENTERED TO SCREEN OR CHASSIS.
- 4. ALL BOXES, CONDUIT AND POWER BY EC. DATA CONNECTORS, PLATE AND CABLE BY LOW VOLTAGE CABLE PROVIDER OR AS WITHIN WRITTEN SPECIFICATIONS.
- COORDINATE REFERENCE POINT LOCATIONS WITH ARCHITECTURAL DRAWINGS.

## AUDIOVISUAL DETAIL - 70" FLAT PANEL DISPLAY - SEMI-RECESSED MOUNTED SCALE: NTS

**100% CD FOR CONSTRUCTION** PROJECT NO. **REVISIONS AUDIOVISUAL DETAILS** W W ENGINEERING E.F. WHITNEY, INC. **RST** KEMPER ARCHITECTS 09.16.14 **APRIL 11, 2016** TRACED 09.18.14 **CITY CENTER CAMPUS** REVISION B **RST** 10.29.14 REVISION C 125 N. HALSTED STREET, 2 N. RIVERSIDE PLAZA 1100 WARRENVILLE **568 ANN STREET** AV 100% DD FINAL REVISION 11.24.15 **JOLIET JUNIOR COLLEGE** 100% CD FOR CONSTRUCTION 03.25.16 CHECKED TA801 BIRMINGHAM, MI 48009 CHICAGO, IL 60606 **SUITE 301** ROAD, #400W CHICAGO, IL 60661 NAPERVILLE, IL 60563 RST P: 312.496.0000 T: 248.644.0990 T: 312.559.4585 T: 312.559.4585

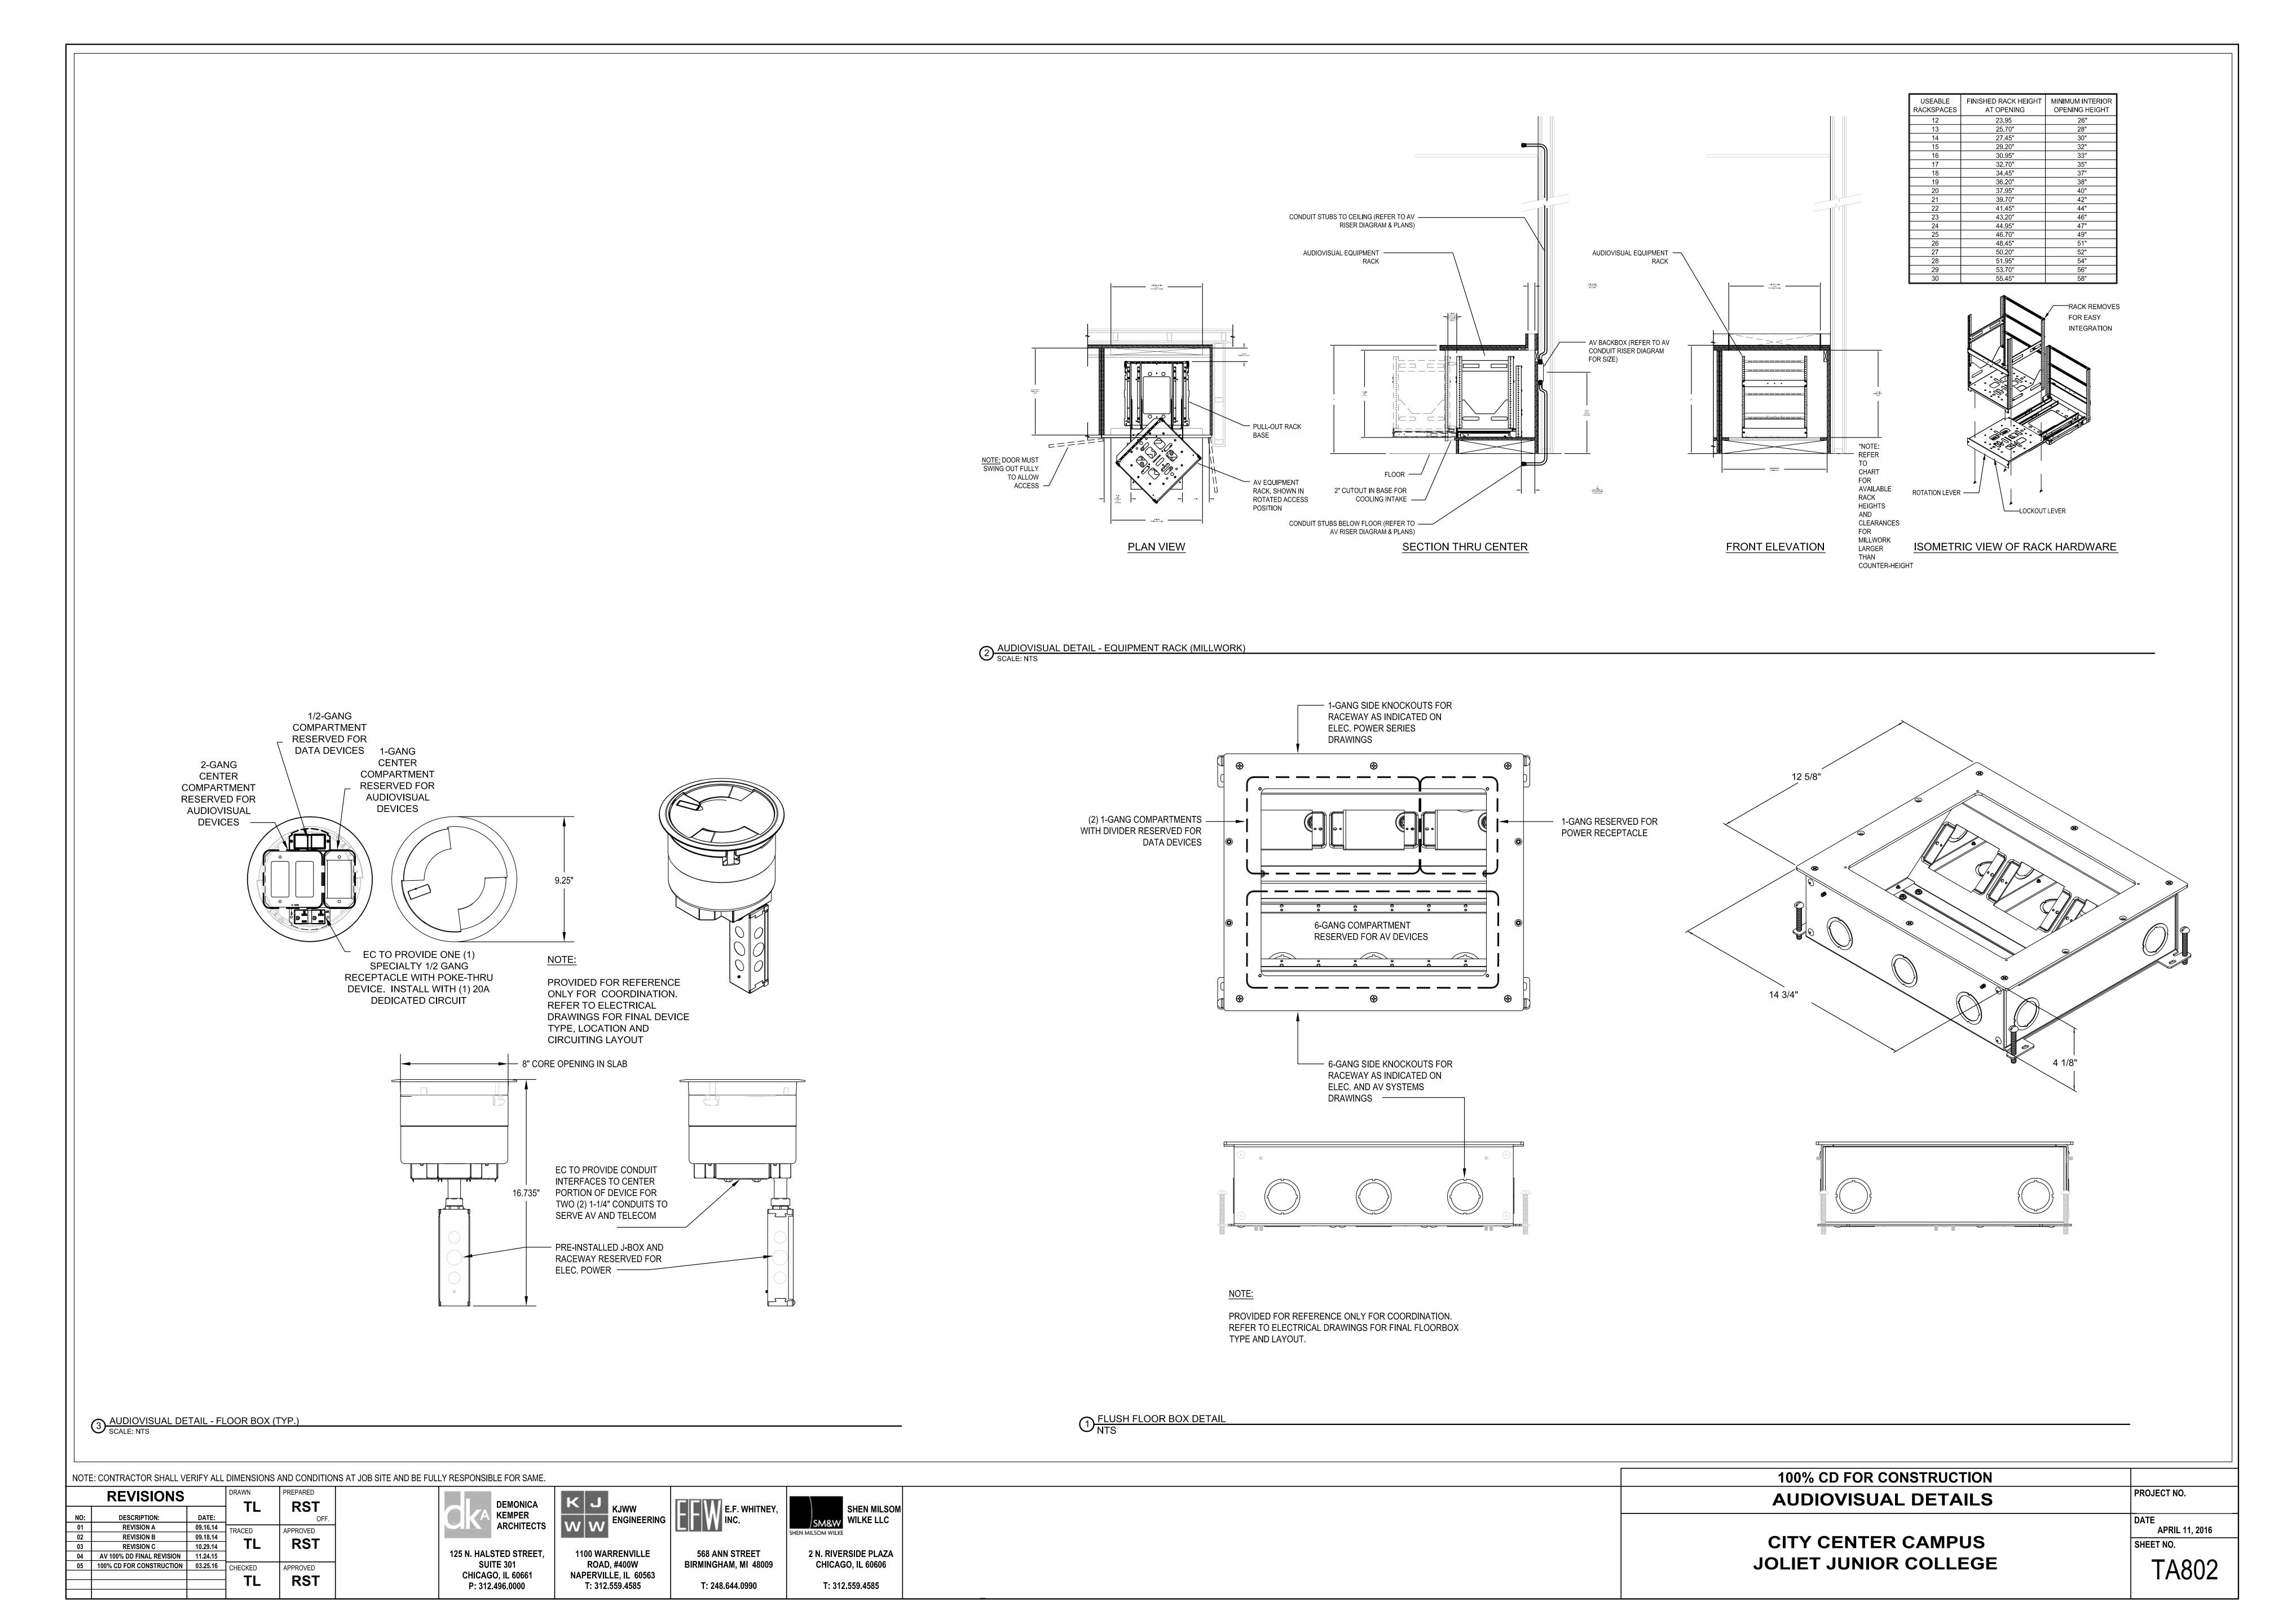

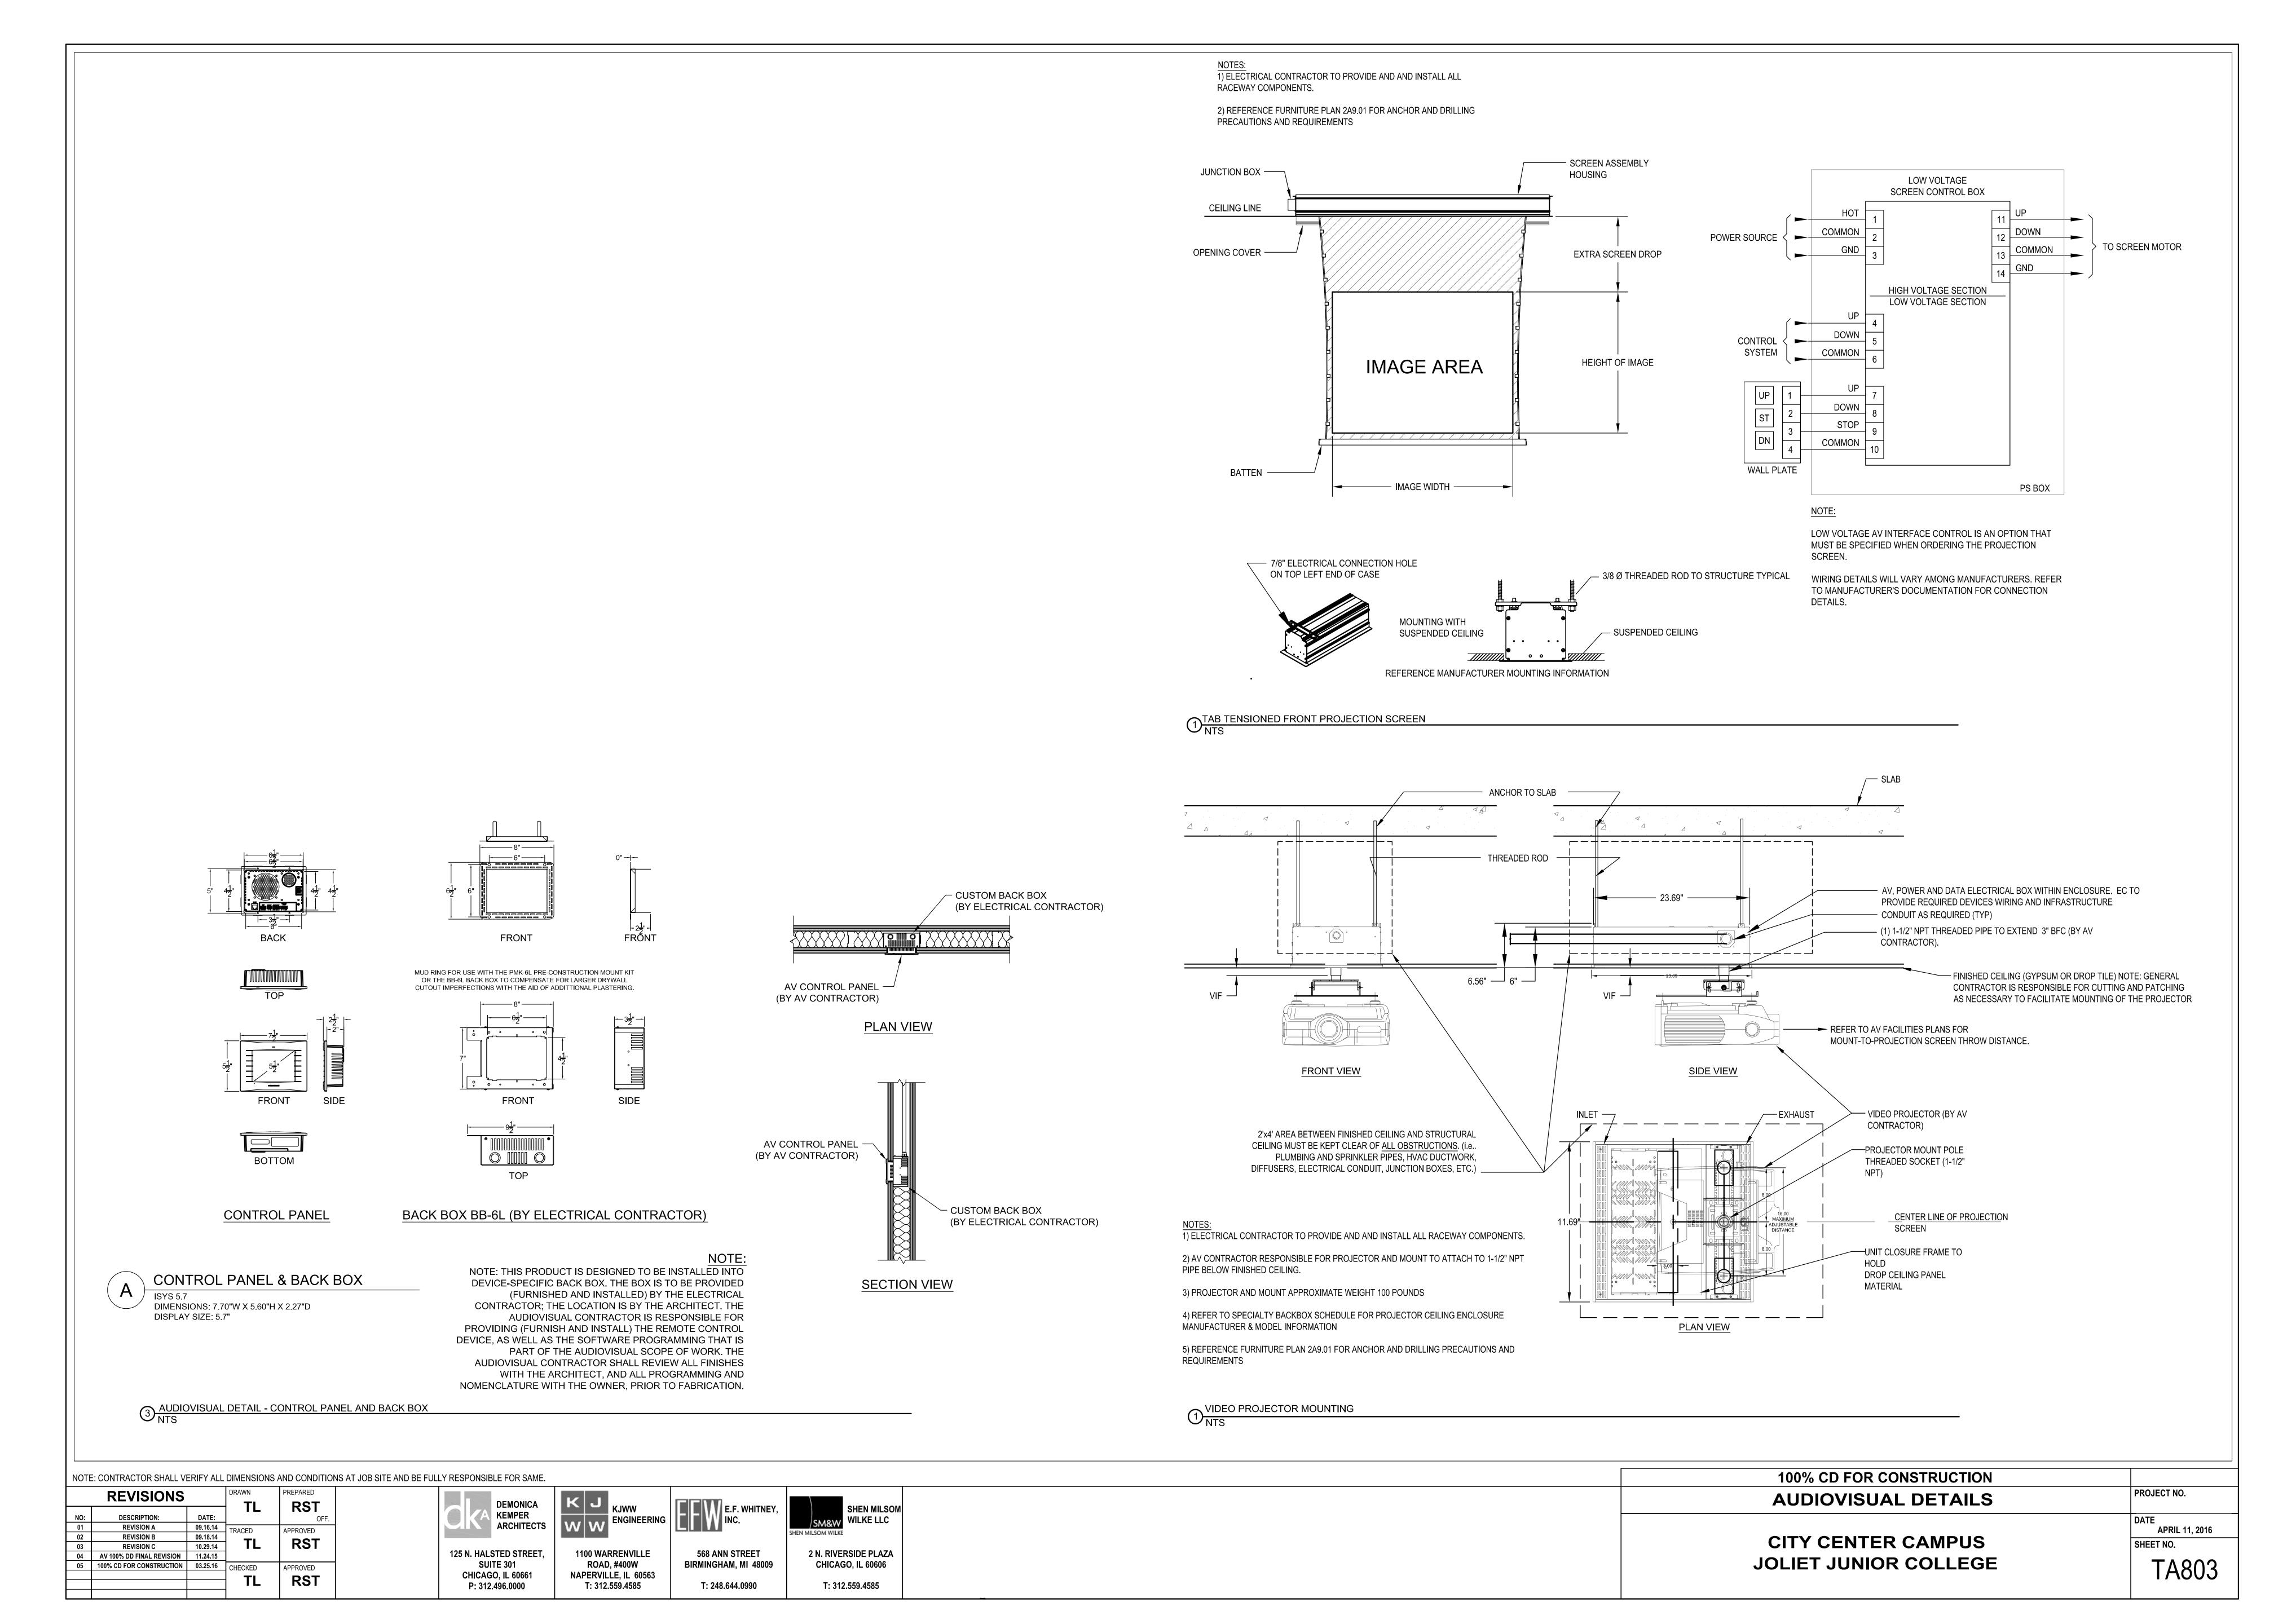

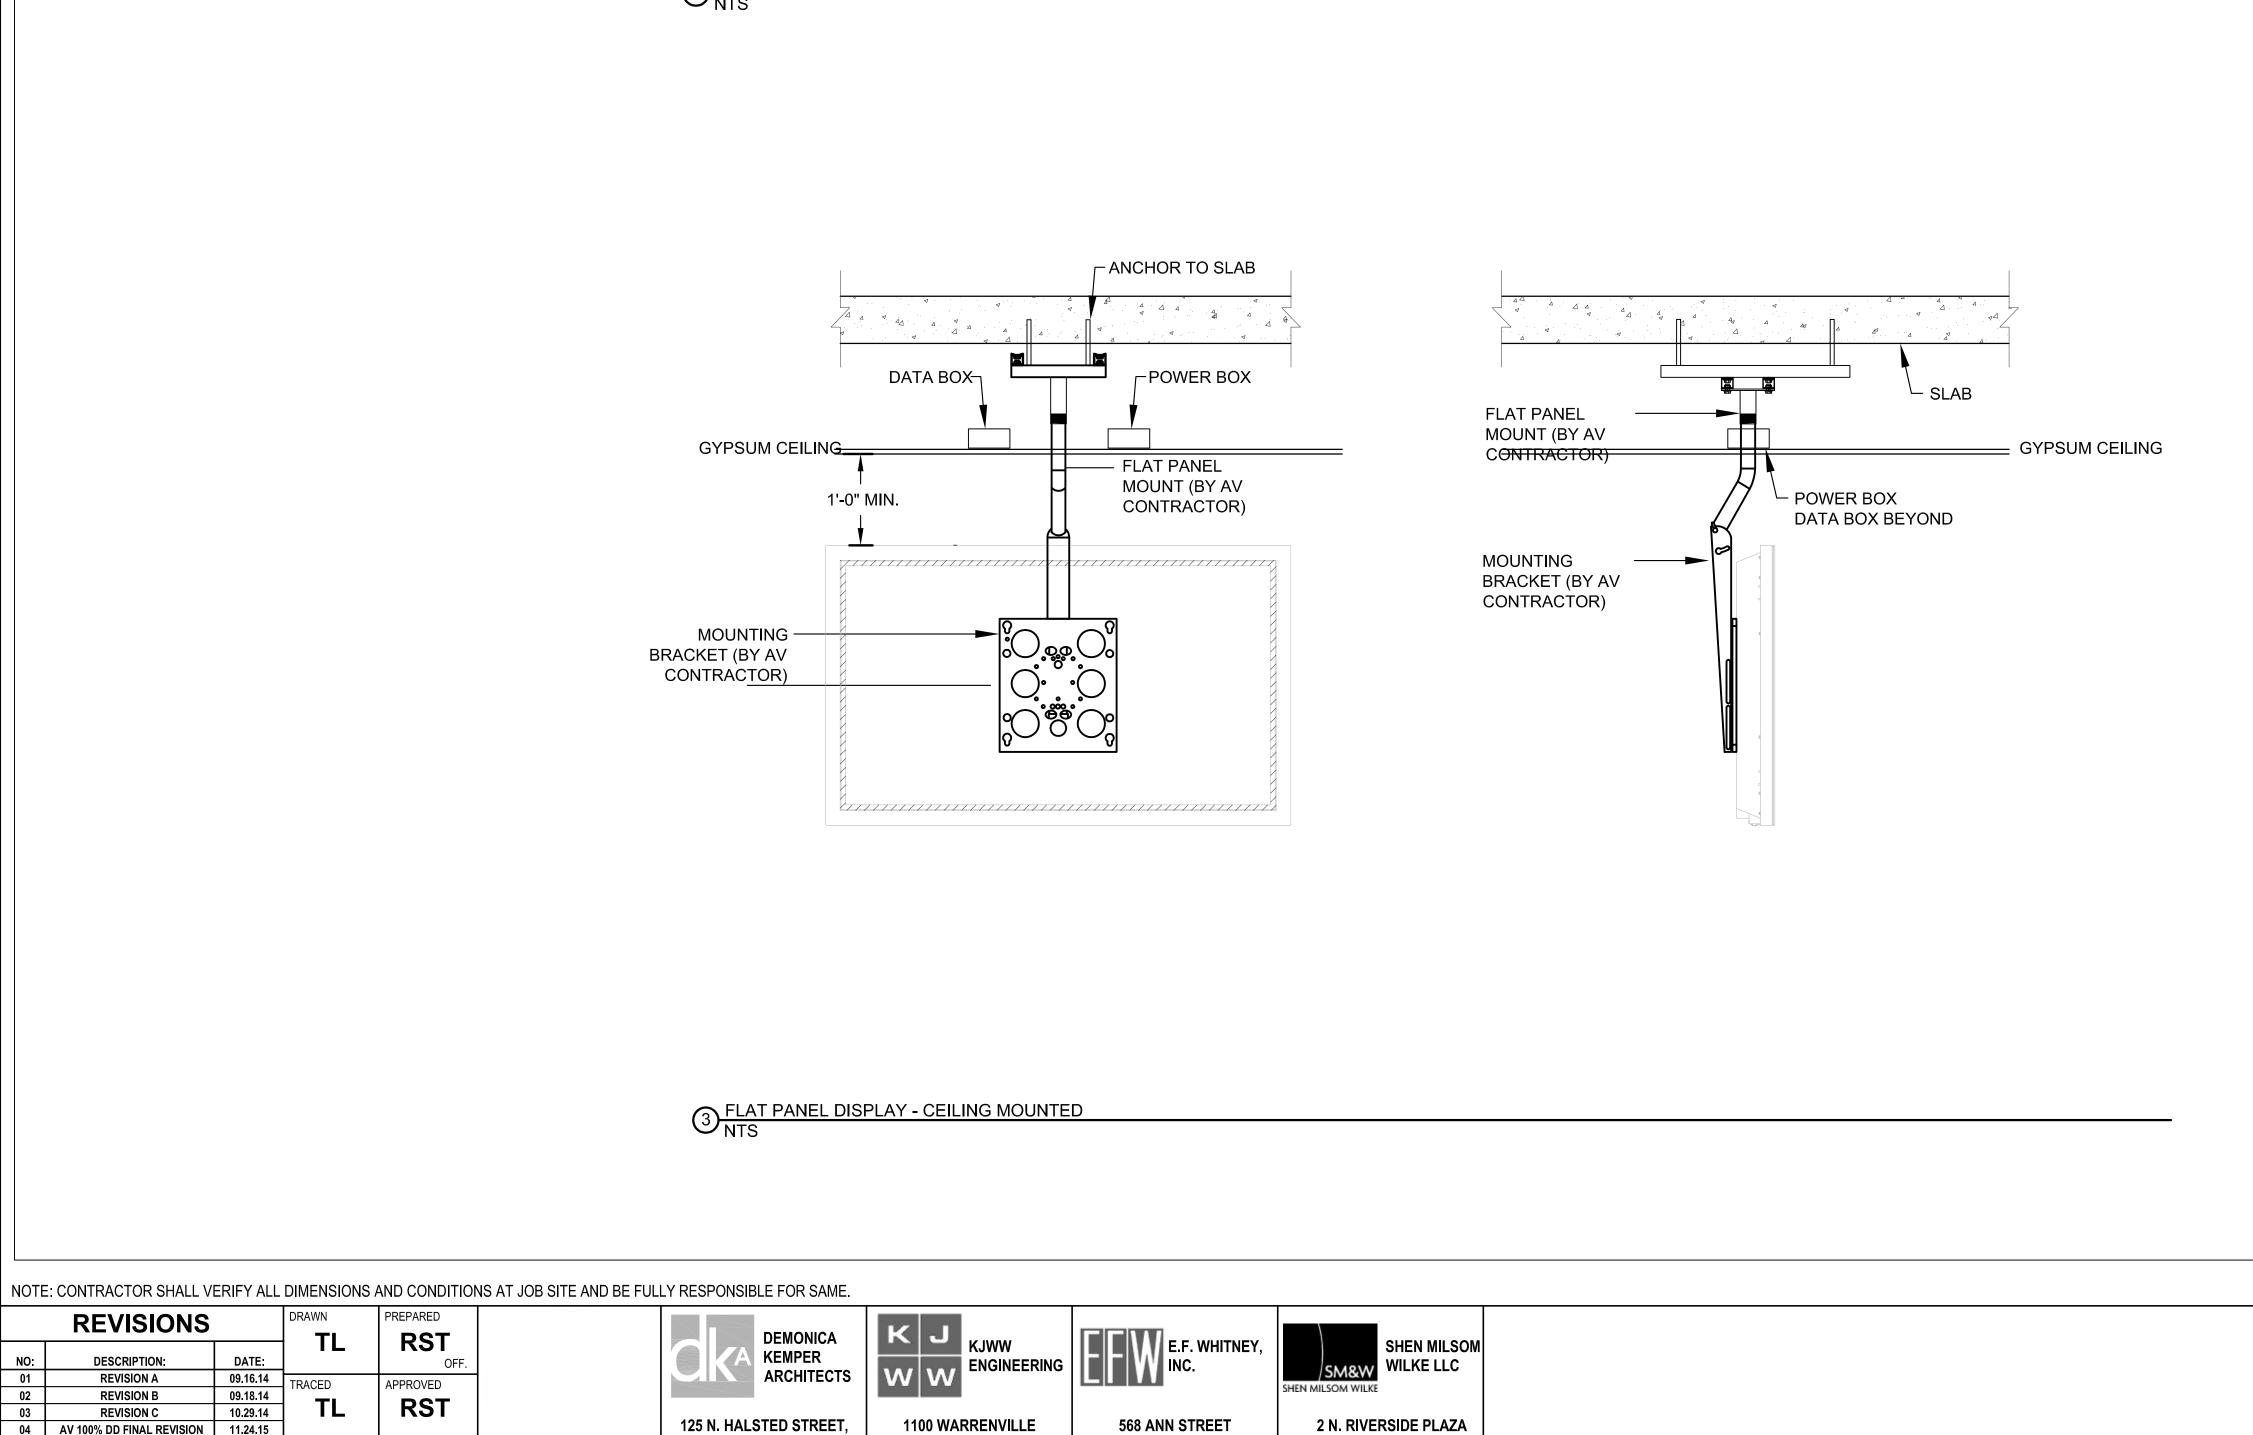


RACK DETAILS

NTS

ALS TX (OFE)

AUDIO DSP BOB (OFE)

EYE HEIGHT SEATED \_\_\_\_\_ 26

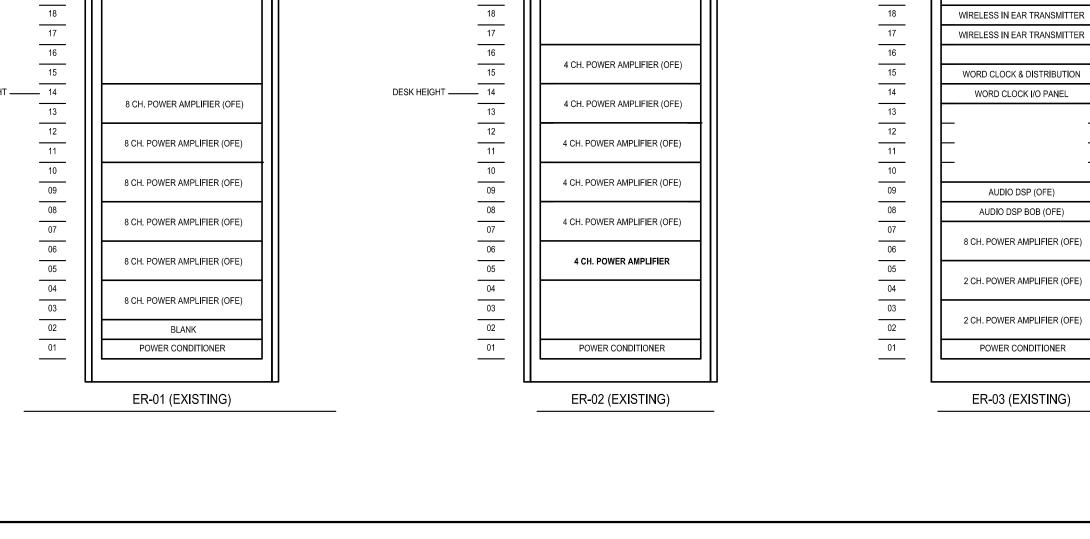


AUDIO DSP BOB (OFE) AUDIO DSP BOB (OFE) AUDIO DSP BOB

4 CH. POWER AMPLIFIER (OFE)

EYE HEIGHT SEATED \_\_\_\_\_ 26

WIRELESS IN EAR ANTENNAE WIRELESS IN EAR ANTENNAE WIRELESS IN EAR TRANSMITTER NOTES: WORD CLOCK & DISTRIBUTION AUDIO DSP (OFE) AUDIO DSP BOB (OFE) WEIGHT: APPROX. 25 LBS. 8 CH. POWER AMPLIFIER (OFE)

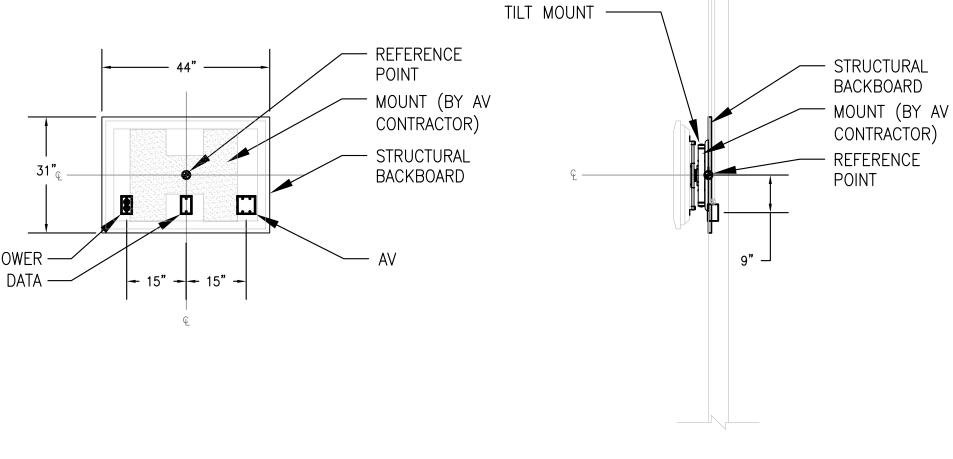

1. HE DIMENSIONING, AS SHOWN, REPRESENTS THE BLOCKING AND BACK BOX POSITIONING REQUIREMENTS FOR A GENERAL CROSS-SECTION OF MANUFACTURERS AND PRODUCTS FOR THIS SIZE FLAT PANEL DISPLAY. DIMENSIONS, AS SHOWN, WILL ACCOMMODATE MOST DISPLAYS CURRENT TO THE MARKET PLACE, BUT MAY NOT REFLECT ALL FUTURE DISPLAYS OR MANUFACTURERS.


2. GENERAL CONTRACTOR TO PROVIDE NECESSARY BLOCKING TO SUPPORT FLAT PANEL DISPLAY.

3. ALL BOXES, CONDUIT AND POWER BY EC. DATA CONNECTORS, PLATE AND CABLE BY LOW

VOLTAGE PROVIDER OR AS INDICATED BY WITHIN WRITTEN SPECIFICATIONS.

4. COORDINATE REFERENCE POINT LOCATIONS WITH ARCHITECTURAL DRAWINGS.

2 AUDIOVISUAL DETAIL - 30" CLASS FLAT PANEL DISPLAY ON TILT WALL MOUNT NTS

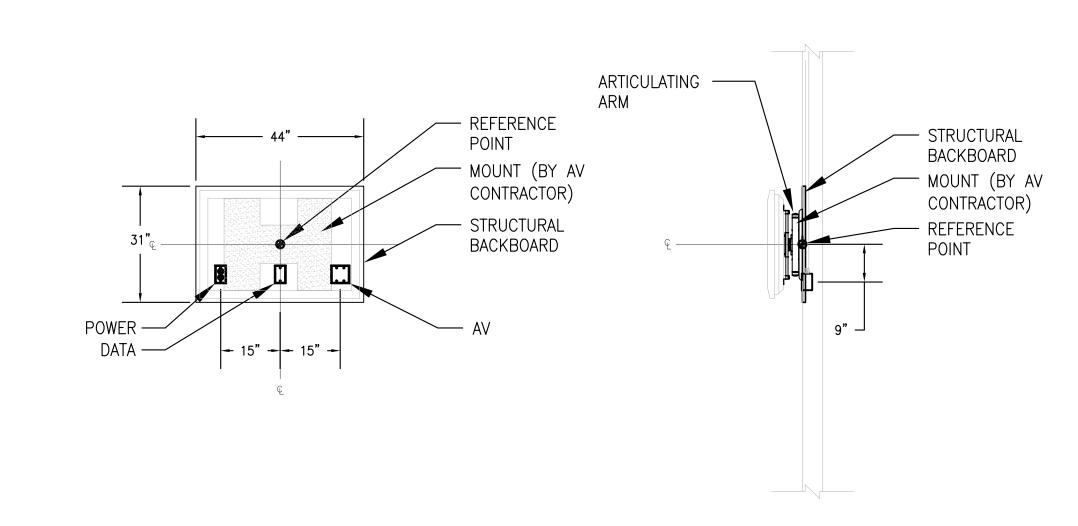

1. HE DIMENSIONING, AS SHOWN, REPRESENTS THE BLOCKING AND BACK BOX POSITIONING REQUIREMENTS FOR A GENERAL CROSS-SECTION OF MANUFACTURERS AND PRODUCTS FOR THIS SIZE FLAT PANEL DISPLAY. DIMENSIONS, AS SHOWN, WILL ACCOMMODATE MOST DISPLAYS CURRENT TO THE MARKET PLACE, BUT MAY NOT REFLECT ALL FUTURE DISPLAYS OR MANUFACTURERS.


2. GENERAL CONTRACTOR TO PROVIDE NECESSARY BLOCKING TO SUPPORT FLAT PANEL DISPLAY. WEIGHT: APPROX. 25 LBS.

3. ALL BOXES, CONDUIT AND POWER BY EC. DATA CONNECTORS, PLATE AND CABLE BY LOW VOLTAGE PROVIDER OR AS INDICATED BY WITHIN WRITTEN SPECIFICATIONS.


4. COORDINATE REFERENCE POINT LOCATIONS WITH ARCHITECTURAL DRAWINGS.


AUDIOVISUAL DETAIL - 30" CLASS FLAT PANEL DISPLAY ON ARTICULATING WALL MOUNT
NTS


100% CD FOR CONSTRUCTION PROJECT NO. **REVISIONS AUDIOVISUAL DETAILS** CDB 810-048-023 DATE CITY CENTER CAMPUS SHEET NO. 125 N. HALSTED STREET, 2 N. RIVERSIDE PLAZA 1100 WARRENVILLE **568 ANN STREET** 04 AV 100% DD FINAL REVISION 11.24.15 **JOLIET JUNIOR COLLEGE** TA804 
 05
 100% CD FOR CONSTRUCTION
 03.25.16
 CHECKED
 **SUITE 301** ROAD, #400W CHICAGO, IL 60606 BIRMINGHAM, MI 48009 CHICAGO, IL 60661 NAPERVILLE, IL 60563 **RST** P: 312.496.0000 T: 312.559.4585 T: 248.644.0990 T: 312.559.4585

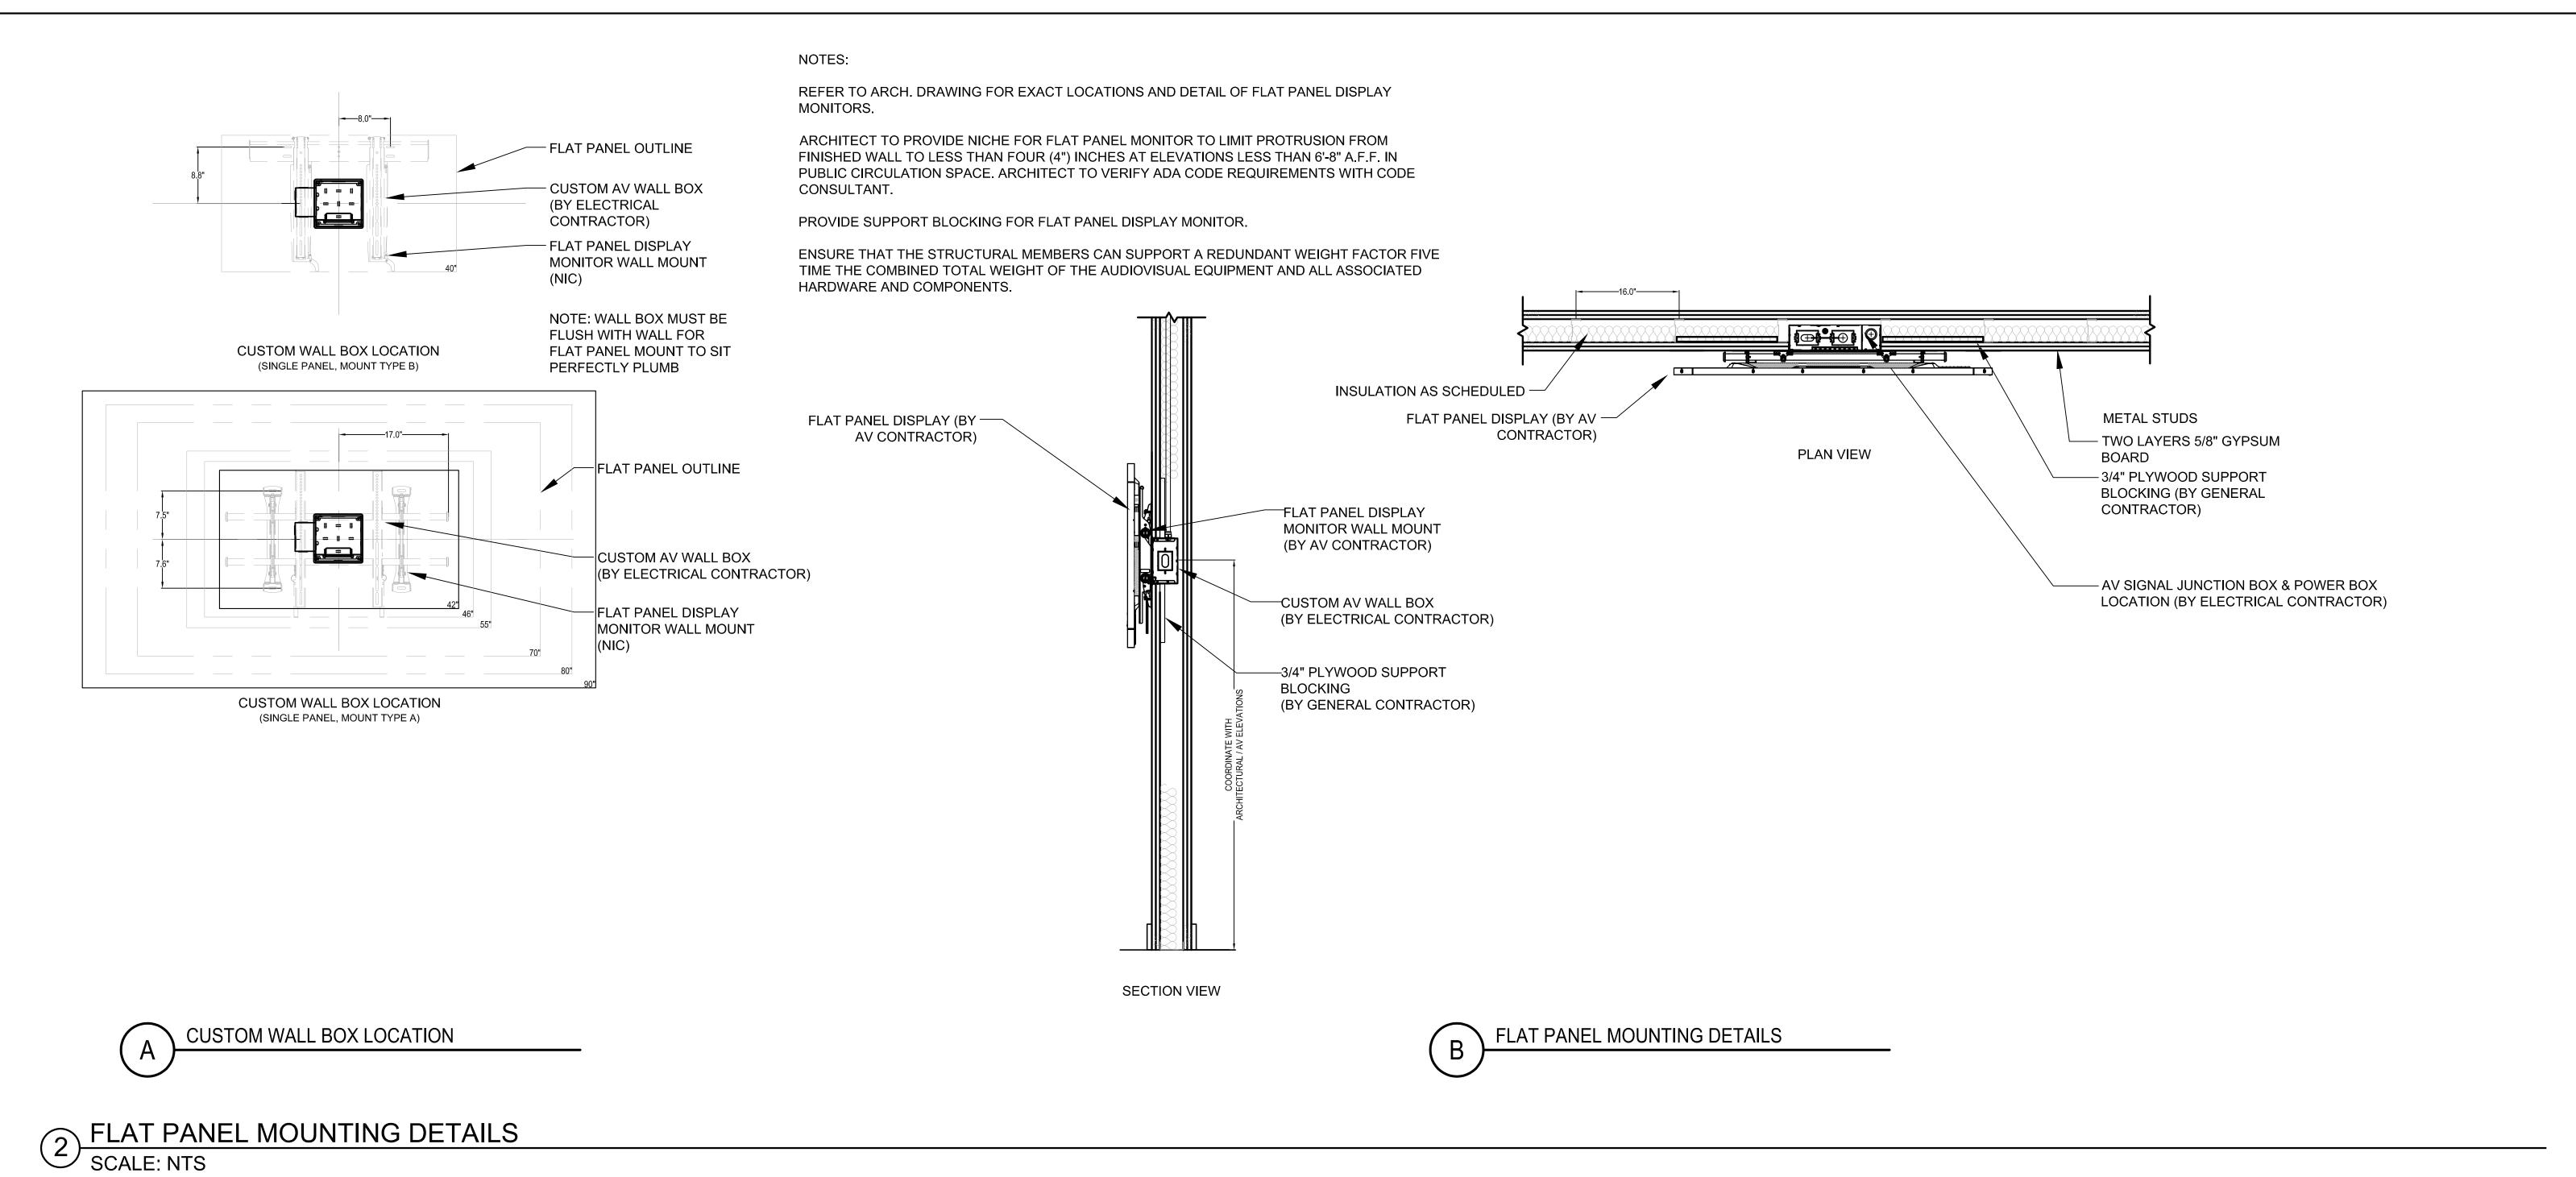



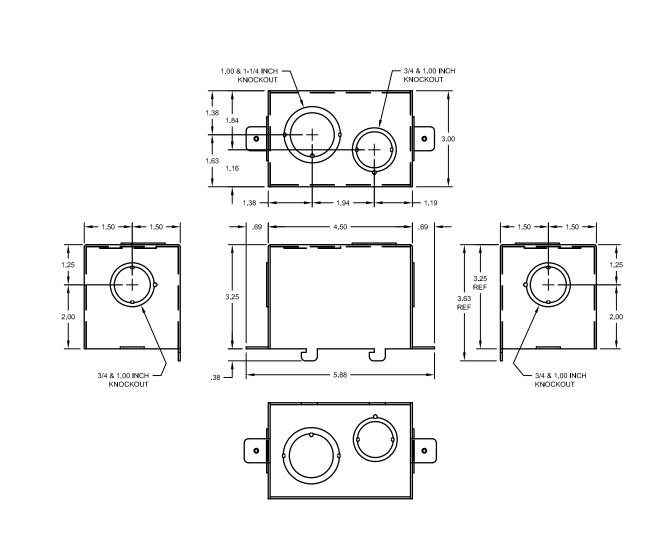

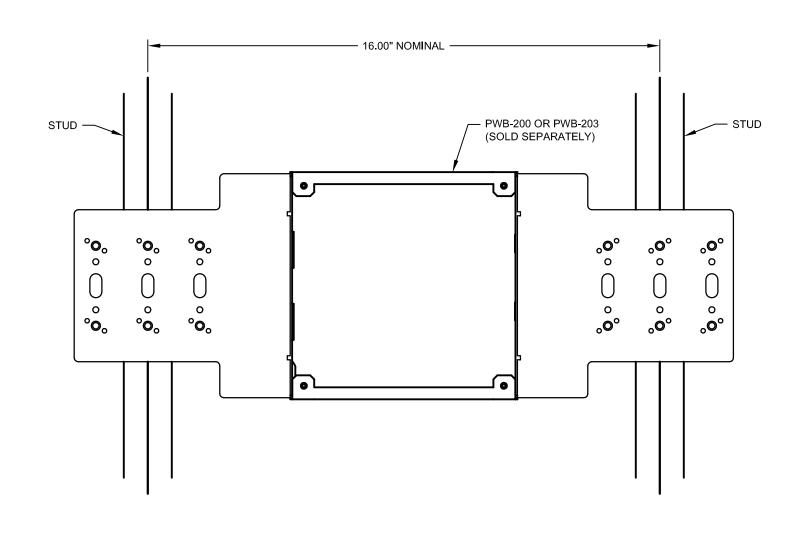

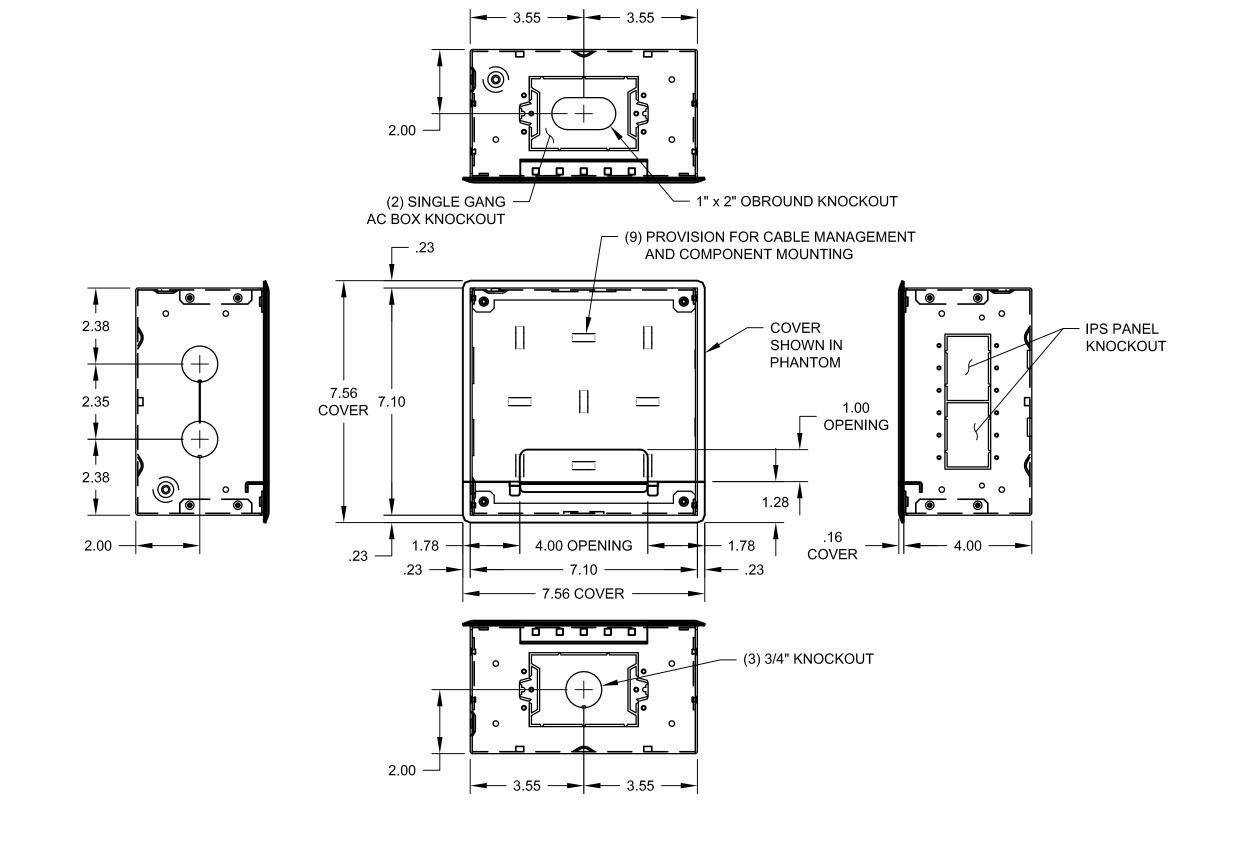

1 FLAT PANEL WALL BOX SCALE: NTS


P: 312.496.0000

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T: 312.559.4585

**100% CD FOR CONSTRUCTION** NOTE: CONTRACTOR SHALL VERIFY ALL DIMENSIONS AND CONDITIONS AT JOB SITE AND BE FULLY RESPONSIBLE FOR SAME. PROJECT NO. **REVISIONS AUDIOVISUAL DETAILS** K J KJWW ENGINEERING E.F. WHITNEY, INC. DEMONICA KEMPER ARCHITECTS RST CDB 810-048-023 DATE REVISION A 09.16.14 TRACED APPROVED REVISION B 09.18.14 **CITY CENTER CAMPUS** RST SHEET NO. 10.29.14 REVISION C 125 N. HALSTED STREET, 2 N. RIVERSIDE PLAZA CHICAGO, IL 60606 1100 WARRENVILLE **568 ANN STREET** 04 AV 100% DD FINAL REVISION 11.24.15 **JOLIET JUNIOR COLLEGE** TA805 05 100% CD FOR CONSTRUCTION 03.25.16 CHECKED **SUITE 301** BIRMINGHAM, MI 48009 **ROAD**, #400W CHICAGO, IL 60661 NAPERVILLE, IL 60563 **RST** 



**REVISIONS RST REVISION A** 09.16.14 TRACED REVISION B 09.18.14 **RST** 10.29.14 REVISION C 04 AV 100% DD FINAL REVISION 11.24.15 
 05
 100% CD FOR CONSTRUCTION
 03.25.16
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DEMONICA KEMPER ARCHITECTS 125 N. HALSTED STREET, **SUITE 301** CHICAGO, IL 60661 P: 312.496.0000

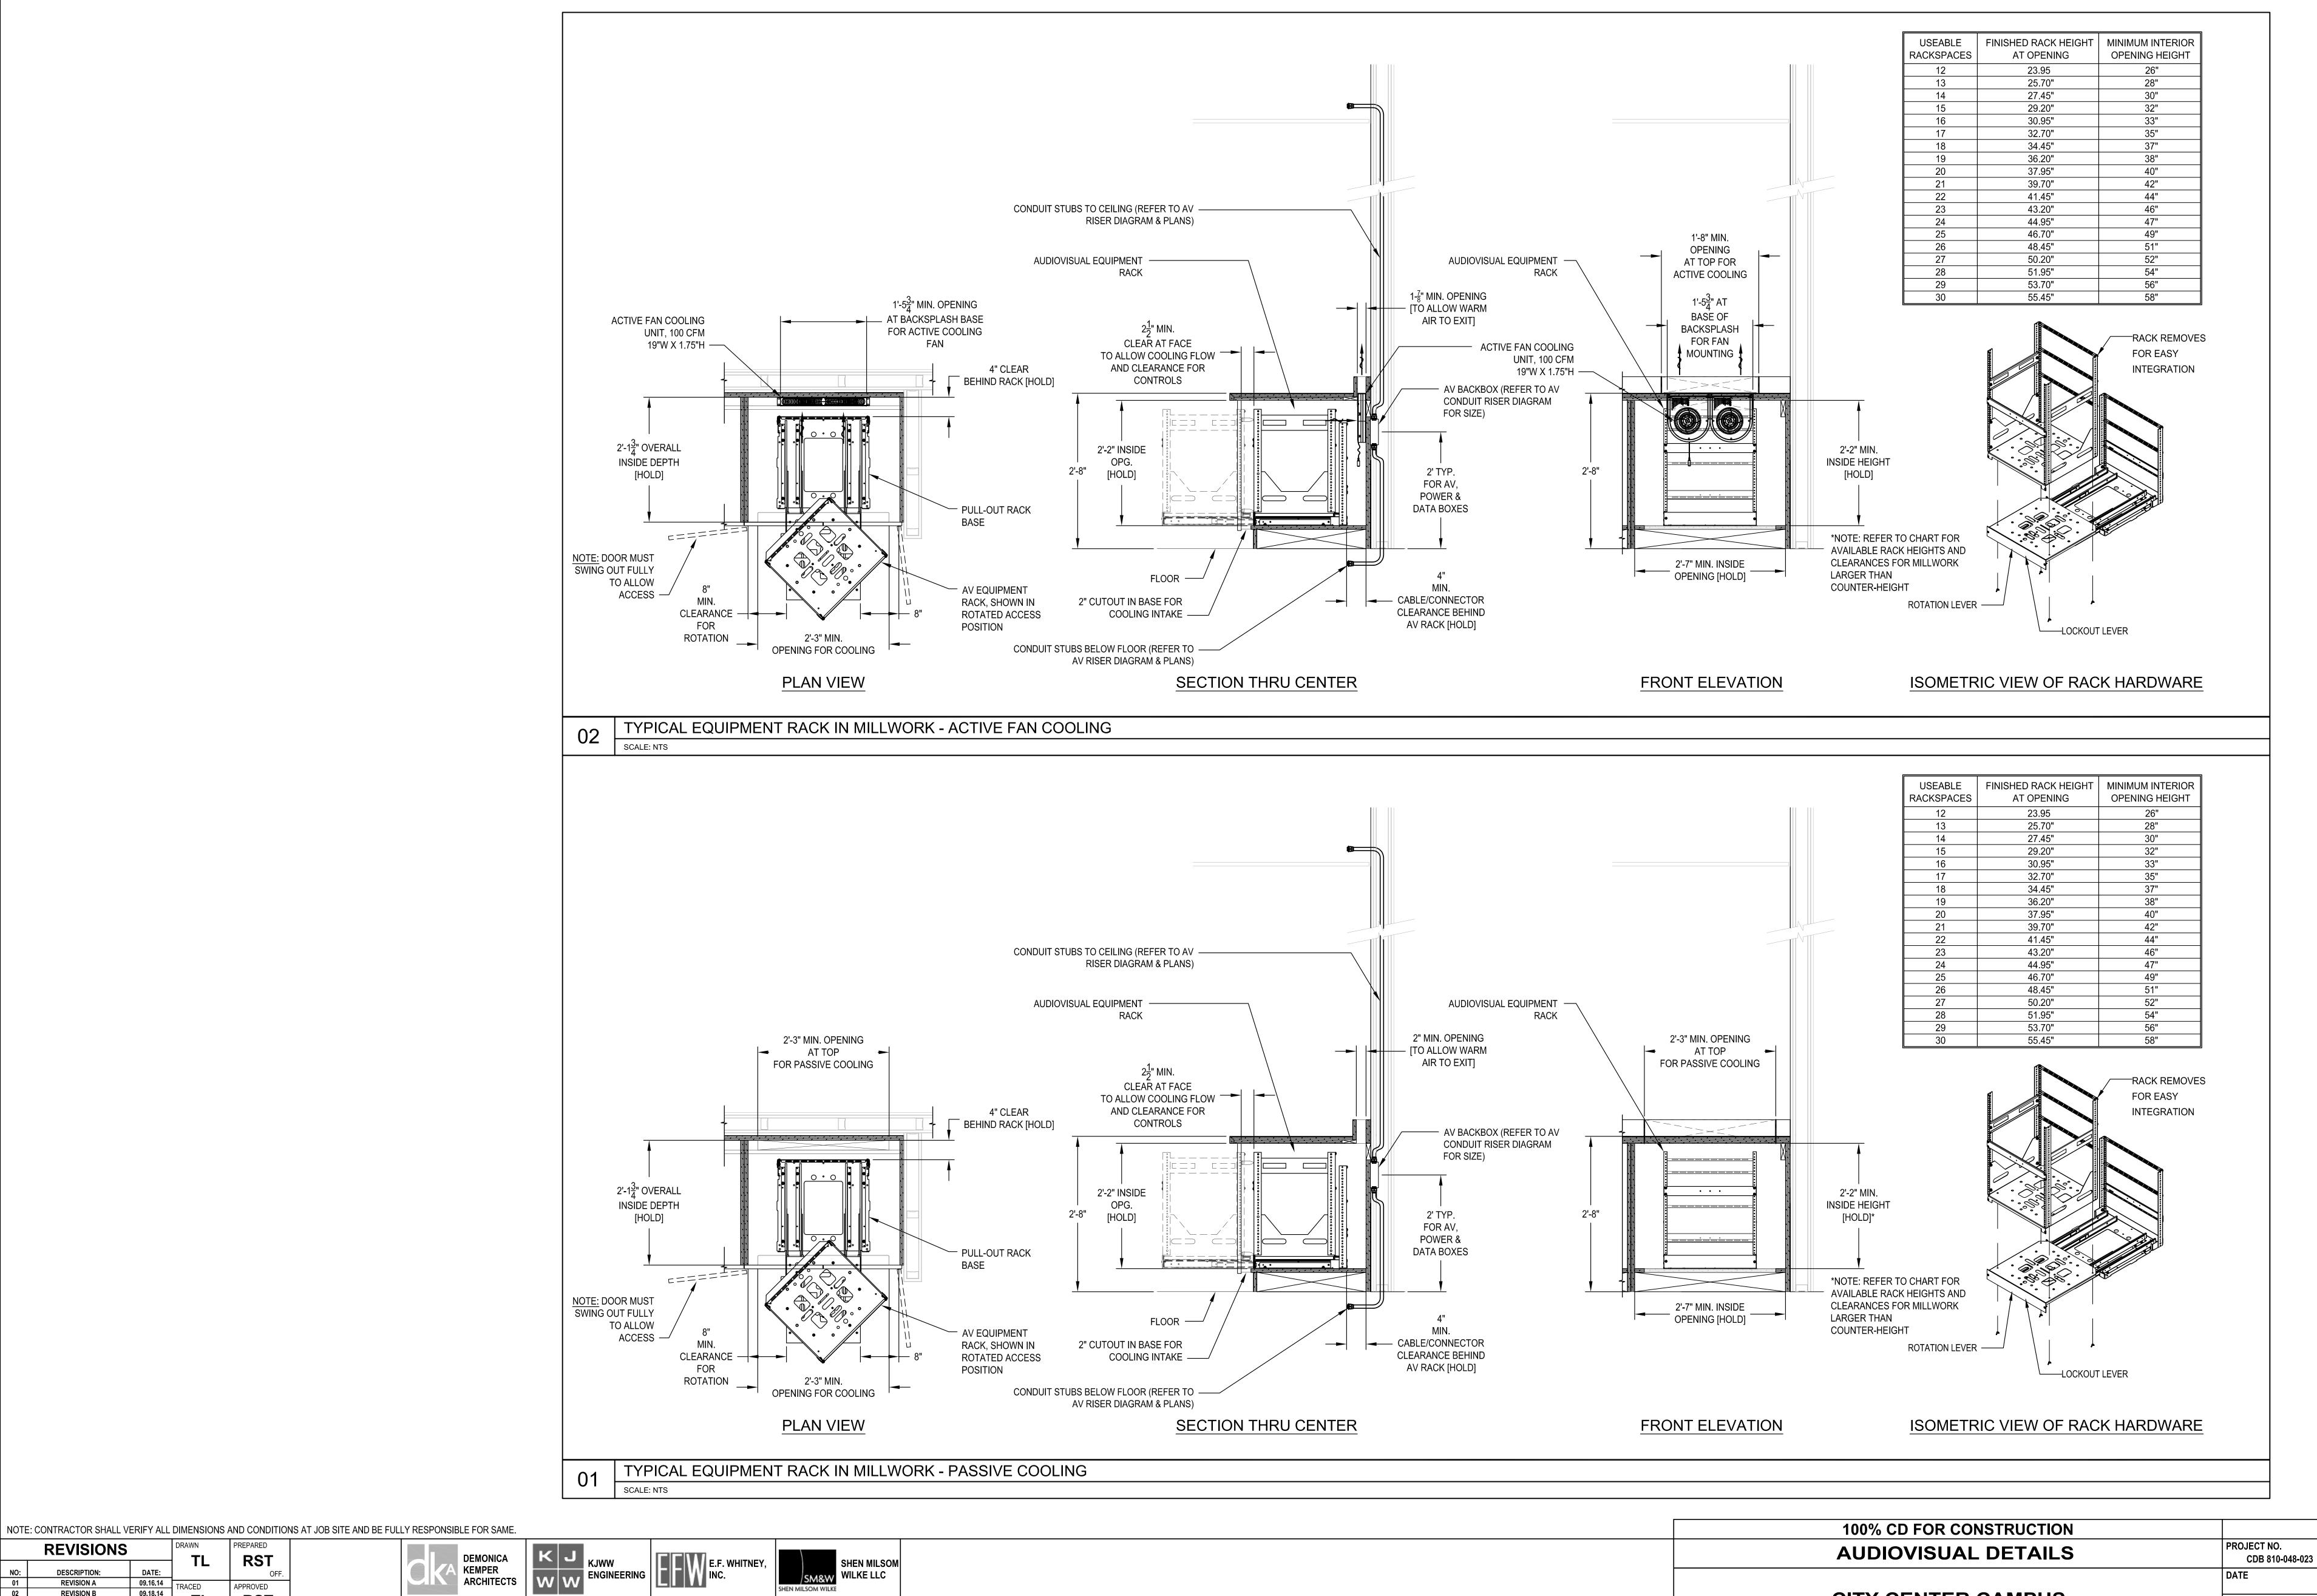

T: 248.644.0990

2 N. RIVERSIDE PLAZA CHICAGO, IL 60606 **568 ANN STREET** BIRMINGHAM, MI 48009 T: 312.559.4585

CITY CENTER CAMPUS **JOLIET JUNIOR COLLEGE** 

SHEET NO. TA806